

#### Owner Change Order

**Change Order Number: 001** 

City of Norman - North Base Complex Phase 1

Flintco LLC (40-000)

1310-1380 DA Vinci Street

Project # 20136

\$64,737.65

Norman, Oklahoma 73069

Date: 1/22/2021

**To Owner:**City of Norman
201-C West Gray
Norman, Oklahoma 73069

**Contract Number:** K-2021-35 **Contract Date:** 10/13/2020

PCO Total:

#### The Contract is hereby revised by the following items:

#### **Details**

Includes Costs for the Following:

- · Additional Tree Removal
- Revision 3 (Exterior)\*\*\*
- · Revision 4
- · Revision 5
- · Revision 6
- RFI #17 Additional Foundations at Fleet Building
- RFI #20 Removal of Existing Unforeseen Pipe
- Bridge Crane Electrical Cost Reduction
- Alternate Non-Prevailing Wage Confirmation\*\*\*
- Delay Receiving Permitted Utility Drawings\*\*\*
- Weather Delay Days Thru 02/05/2021\*\*\*

Items with \*\*\* have no cost impact.

PCO#	Title	Amount
001	Additional Tree Removal, Rev 3 (Exterior), Rev 4, Rev 5, Rev 6, RFI #17, RFI #20, Bridge Crane Cost Reduction, Alternate Non-Prevailing Wage Confirmation, Delay Receiving Permitted Utility Drawings & Delay Days Thru 02/05/2021	\$64,737.65

The original Contract Value	\$8,648,000.00
Sum of changes by prior Prime Contract Change Orders	\$0.00
The Contract Value prior to this Prime Contract Change Order	\$8,648,000.00
The Contract Value will be changed by this Prime Contract Change Order in the amount of	\$64,737.65
The new Contract Value including this Prime Contract Change Order will be	\$8,712,737.65
The Contract duration will be changed by	22 days
The revised Substantial Completion date as of this Prime Contract Change Order	8/31/2021

### Change Order No. One to Contract K-2021-35

Flintco, LLC	City of Norman
CONTRACTOR	OWNER
2302 S. Prospect Oklahoma City, Oklahoma 73129	201-C West Gray Norman, Oklahoma 73069
Address	Address
Ву	By Breea Clark, Mayor
SIGNATURE	SIGNATURE
DATE	DATE
GSB, Inc. Architects & Planners  ARCHITECT  3555 NW 58TH Street, Suite 700W Oklahoma City, OK 73112	ATTEST:
Address	City Clerk
Ву	
SIGNATURE	Approved by the City Attorney's Office on
DATE	, 2021, by

PROPOSE	D CHANGE ORDER SUMMARY CONSTRUCTION MANAGER	Construction Manager:			
		Flintco, LLC			
THE CITY O					
•	Norman North Base - Phase 1 / 20136 (Main Job)	4			
PCO No.:	#001 Additional Tree Removal, Rev 3 (Exterior), Rev 4, Rev 5, Rev 6, RFI #17 Additional Foundations at Fleet Building, RFI #20 Removal of Existing Unforseen Pipe, Bridge Crane Cost Reduction, Delay Receiving Permitted Utility Drawings & Delay Day Thru				
PCO Title: PCO Date:	02/05/2021 12/22/2021 (Revised 02/19/2021)				
 1.	Subcontractors' Work (enter amounts from Subcontractor Summary Sheets)				
DIV 02	Midwest Wrecking (Additional Tree Removal)		\$	1,725.00	
DIV 26	DSE (Rev 4)	-	\$	1,276.00	
DIV 32	Turning Point (Rev 4)	-	\$	180.00	
DIV 33	H&H (Rev 4)	-	\$	11,390.00	
DIV 26	DSE (Rev 5)	-	\$	2,253.00	
DIV 33	H&H (Rev 6)	-	\$	10,025.00	
DIV 26	DSE (Bridge Crane)		\$	(387.00	
	, , ,		,	,	
	Subtotal for Subcontractors' Work	_	\$	26,462.00	
2.	Itemized Direct Project Management Cost Increases (if any)				
	Field Engineer (Layout): 4 Days @ \$70/HR		\$	2,240.00	
	Labor Foreman: 0 Days @ \$65/HR		\$	-	
	Burden Rate (58% DPM Costs)	_	\$	1,299.20	
		_			
	Subtotal for Direct Project Management Cost Increases (if any)		\$	3,539.20	
	Subtotal 1. + 2.	-	\$	30,001.20	
		_			
3.	Construction Manager's Self Performed Work	_			
DIV 02	Removal of Existing Unforseen Pipe (RFI #20): See Attached Spreadsheet	_	\$	3,944.96	
DIV 03	Additional Foundations at Fleet Building (RFI #17): See Attached Spreadsheet	_	\$	11,470.93	
DIV 03	Concrete (Rev 5): See Attached Spreadsheet	_	\$	9,876.97	
	Clean-Up: 4 Days @ \$45/HR (Incl. Burden Rate @ 58%)	-	\$	2,275.20	
	Subtotal for Construction Manager's Self Perfrom Work		\$	27,568.06	
		-			
	Subtotal, Cost of Work and Direct Proj Mgmt Cost		\$	57,569.26	
4.	Construction Manager Fee (Percent of Subtotal 1. and 2. above)	10.00%	\$	3,000.12	
<u> </u>	Construction Manager Overhead(Percent of Subtotal 1. and 2. above)	5.00%	\$	1,500.06	
6.	CM's Liability Insurance	0.65%	\$	403.45	
7.	Subcontractor Default Insurance, if authorized (% of Subcontractor Subtotal)	1.60%	\$	999.57	
8.	CM's Builders Risk Insurance	0.55%	\$	349.10	
9.	Project Bonds	0.82%	\$	523.34	
	Total Cost of Change		\$	64,344.89	

Architect/Engineer

Owner

Construction Manager

PROPOSE	D CHANGE ORDER SUMMARY CONSTRUCTION MANAGER	Construction I	Construction Manager:				
		Flintco, LLC					
THE CITY OF							
	Norman North Base - Phase 1 / 20146 (Alternate)						
PCO No.:	#001	_					
PCO Title:	Rev 5 & Alternate Non-Prevailing Wage Confrimatior	_					
PCO Date:	12/22/2021						
1.	Subcontractors' Work (enter amounts from Subcontractor Summary Sheets)						
			\$	_			
		_	\$	_			
		_	\$	_			
		_					
		_					
	Subtotal for Subcontractors' Work		\$	_			
	Cubicial for Cubicontractors Work	-	Ψ	_			
2.	Itemized Direct Project Management Cost Increases (if any)						
	Field Engineer (Layout): 0 Days @ \$70/HR		\$	-			
	Labor Foreman: 0 Days @ \$65/HR	_	\$	_			
	Burden Rate (58% DPM Costs)	_	\$	-			
	\\\\\\\\\\\\\\\\\\\\\\\\\\\\\\\\\\\\\\		Ť				
	Subtotal for Direct Project Management Cost Increases (if any)	_	¢				
		-	\$	-			
	Subtotal 1. + 2.	_	\$	-			
	Out to the Manual Colf Defendable I	_					
3.	Construction Manager's Self Performed Work	_					
DIV 03	Concrete (Rev 5): See Attached Spreadsheet	_	\$	378.87			
	Clean-Up: 0 Days @ \$45/HR (Incl. Burden Rate @ 58%)	_	\$	-			
		_					
		_					
		-					
		_	_				
		_	•	270.07			
	Subtotal for Construction Manager's Self Perfrom Work	_	\$	378.87			
	Subtotal, Cost of Work and Direct Proj Mgmt Cost						
	Captotal, Coot of Hork and Direct 15) inglist Coot		\$	378.87			
	0						
4.	Construction Manager Fee (Percent of Subtotal 1. and 2. above)	10.00%	\$	-			
5.	Construction Manager Overhead(Percent of Subtotal 1. and 2. above)	5.00%	\$	-			
6.	CM's Liability Insurance	0.65%	\$	2.46			
7.	Subcontractor Default Insurance, if authorized (% of Subcontractor Subtotal)	1.60%	\$	6.10			
8.	CM's Builders Risk Insurance	0.55%	\$	2.13			
9.	Project Bonds	0.82%	\$	3.19			
	Total Cost of Change		\$	392.76			
Approved for	Construction Any cost component may be adjusted in accordance with the Agreemen	t for At-Risk Cons	truction	Management			
Services.				=			
Construction Mar	ager Architect/Engineer Owner			<del></del>			
_ J							

# ADDITIONAL TREE REMOVAL



November 16th, 2020

Flintco

Attn: Phillip

Email: phillip.gunderson@flintco.com


Re: City of Norman- North base complex- Phase 1 Norman, OK

We propose and agree to furnish all labor, material, equipment, and insurance necessary to complete subject work as follows:

- 1. Remove and haul off trees located around existing parking lot.
- 2. All materials will be hauled off site and disposed of, proposal includes all disposal fees.

This work will be completed for the sum of \$1,725.00 (One Thousand Seven Hundred Twenty Five Dollars).

If you have any questions regard	ing this proposal, please contact me at (405) 478-8833.
Respectfully,	Date:
Bryan Gann	Accepted:
Project Estimator	

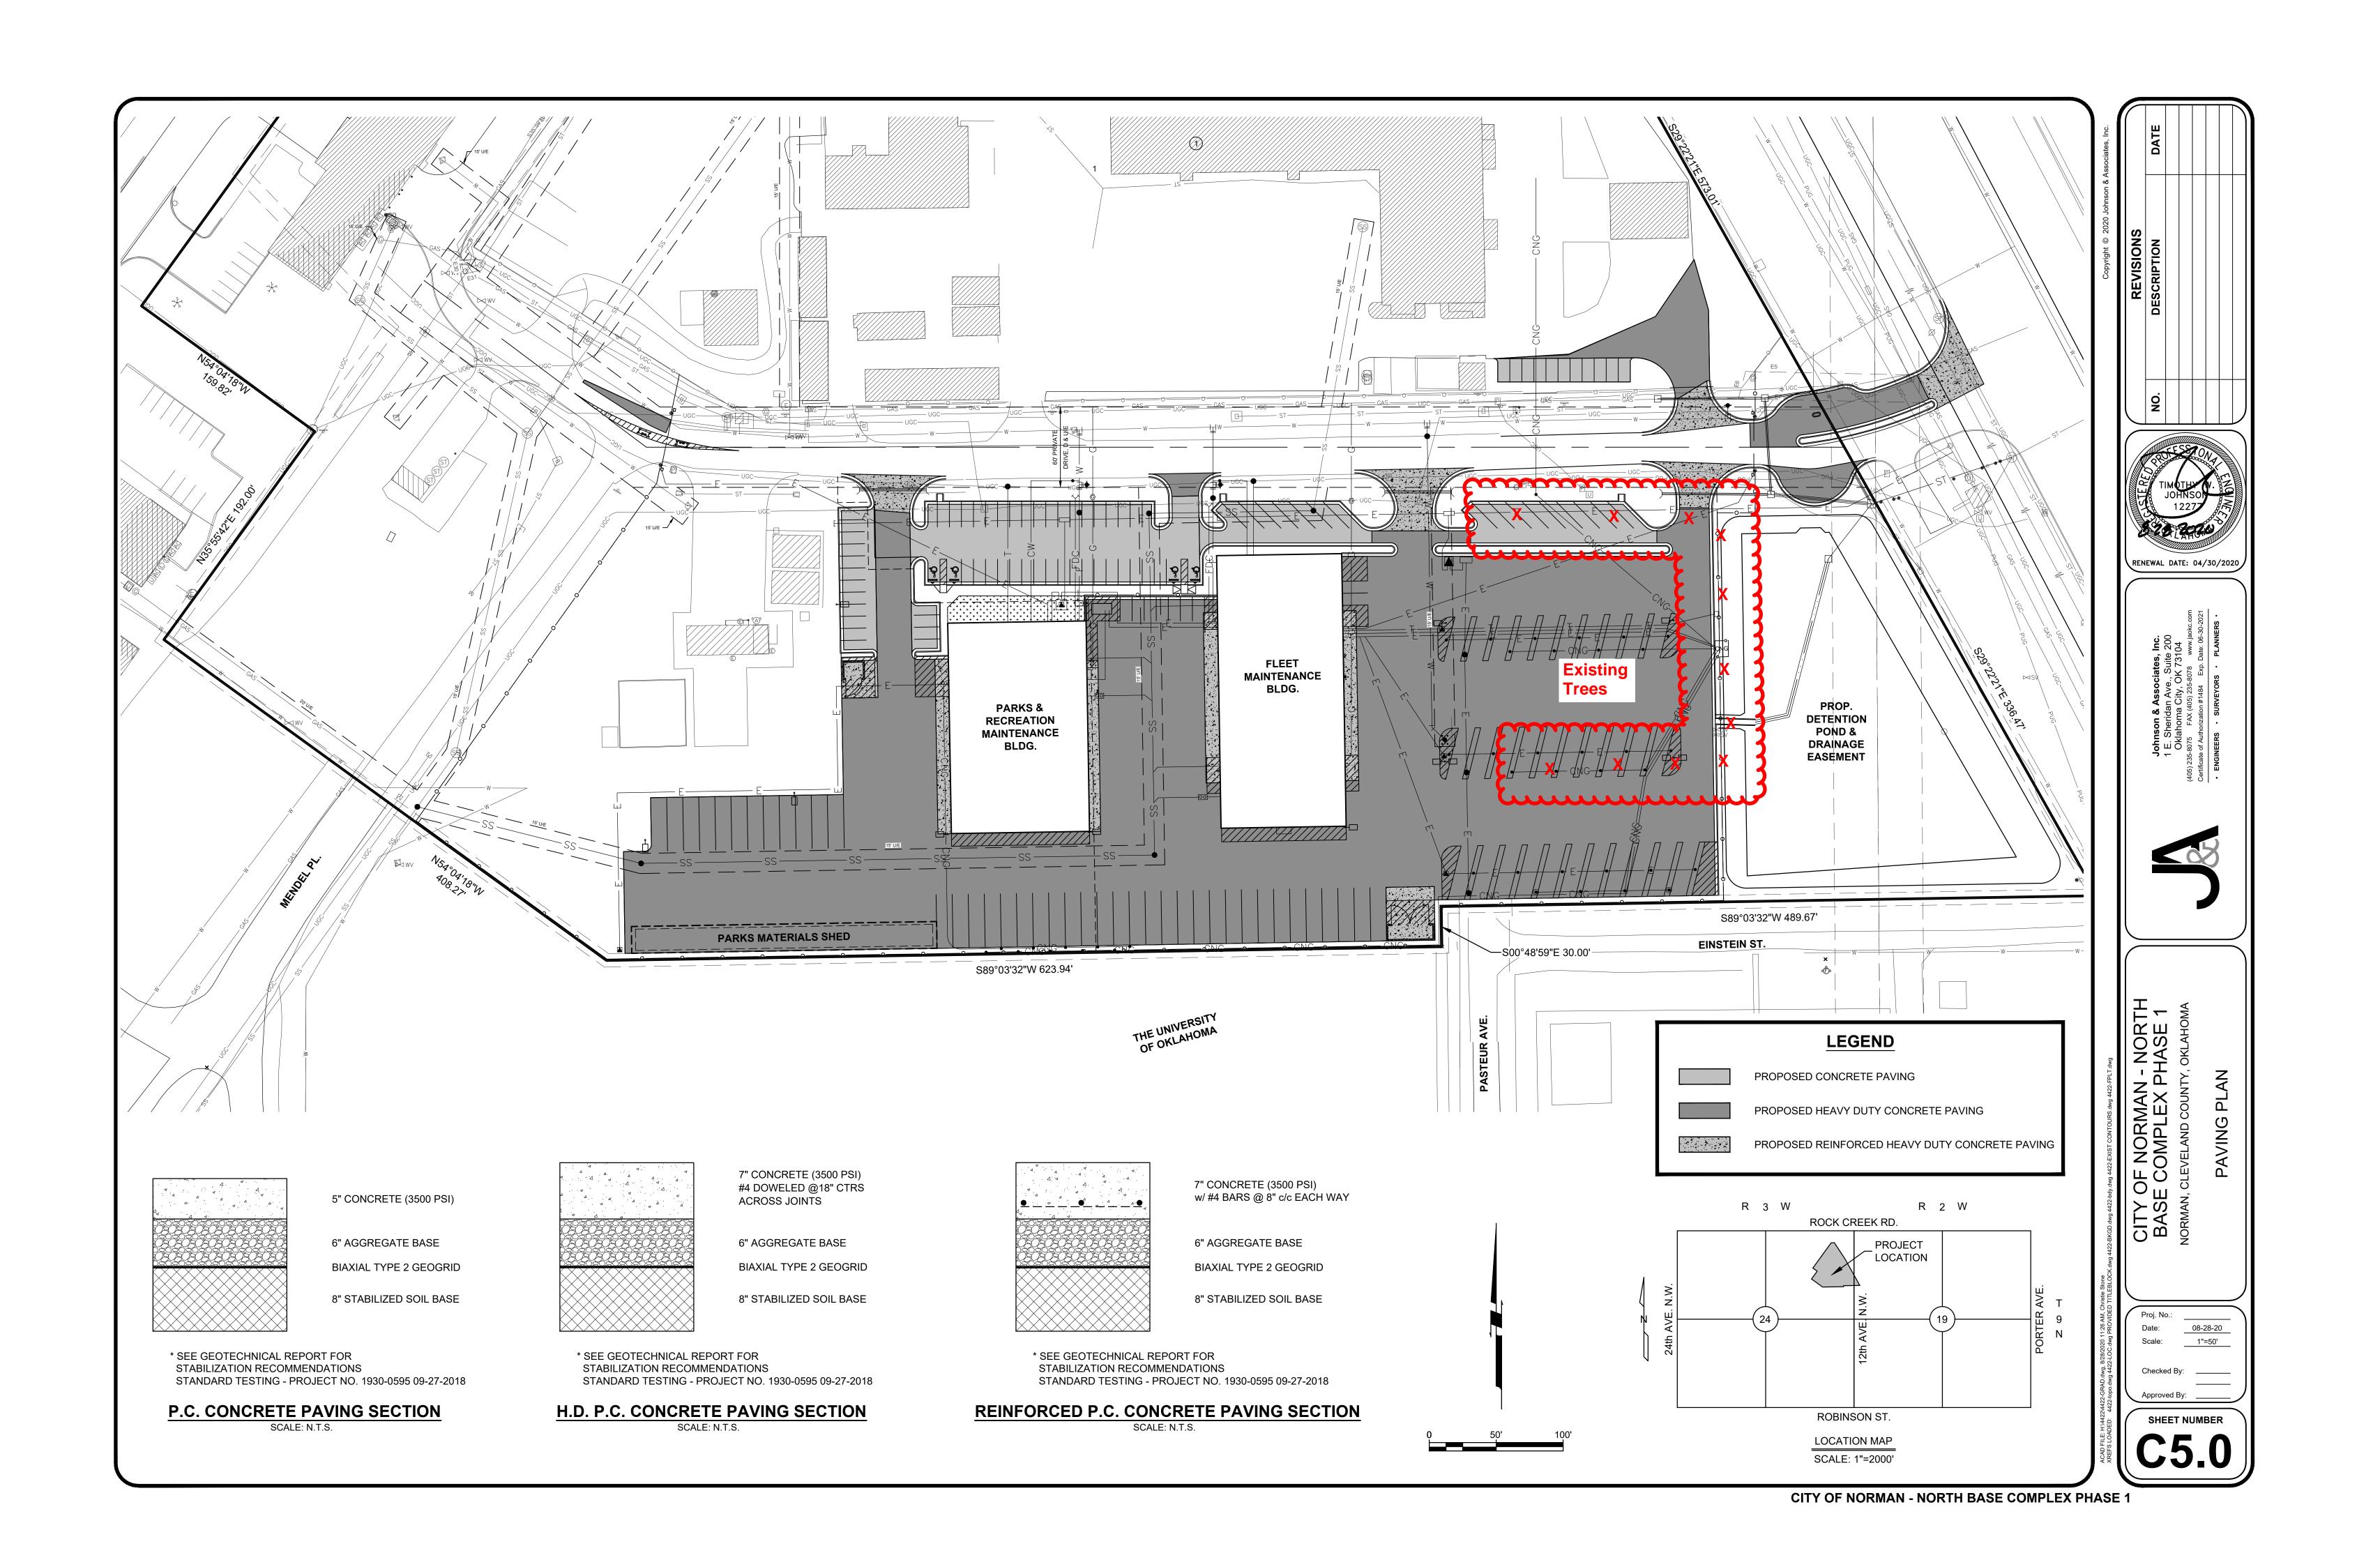



ARCHITECT GSB, INC 3555 NW 58th Street, Suite 700W Oklahoma City, OK 73112

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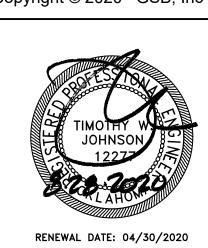
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LANDSCAPE ARCHITECT 5314 SOUTH YALE AVE - STE. 510

PLANNING DESIGN GROUP TULSA, OKLAHOMA 74135 (918) 628-1255 www.planningdesigngroup.com



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REVISIONS

NO. DATE DESCRIPTION

GSB PROJECT NO.

DRAWING TITLE PAVING PLAN

DRAWING NO.

C5.0

# **REVISION 3**

No Additional Costs for Exterior Improvements (Includes: Added required safety markings on paving denoting designated travel paths to dumpster enclosures)

Cost for Interior Additions Pending
(Includes: Additional Equipment Added to Equipment Plans &
Added required safety markings on floor denoting egress path in
cleaning bay)

# **REVISION 4**

# Change Order No. One to Contract K-2021-35

DSE Bidding and Estimating Form


Job: North Base Labor Area: EV MODIFICATIONS Material Hours. Enter E. C or W in Unit this will add a total of 150" of 1" conduit and (2) 55" runs of 4" conduit. Unit Oty. tem 97.50 1 386.10 35.10 2 10' sticks of 1" PVC 12.00 15 3 10" sticks of 4" PVC 11 e 4 1 man 12 hours labor 5 6 7 8 9 10 11 12 13 14 15 16 17 18 19 20 21 22 23 24 25 26 27 28 29 30 31 483.60 12.00 Totals 720 Total Labor Labor Hour Rate 559 Total Material

Total Page 1

Tax Rate 15.00% Profit

0 **Total Opening** 1,276

Page #

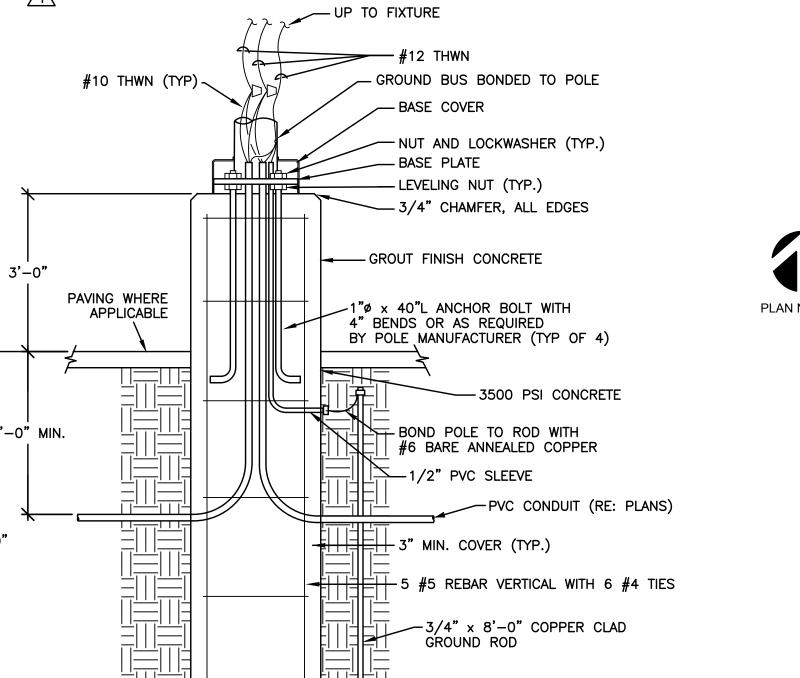

24"

DIAMETER

POLE BASE DETAIL

E1-01 NOT TO SCALE

1" CONDUIT ROUTED

UNDERGROUND FOR POWER TO PEDESTAL


DIAMETER


SIDE VIEW

E1-01 NOT TO SCALE

© RECEPTACLE PEDESTAL DETAIL

RECEPTACLE (TYPICAL)

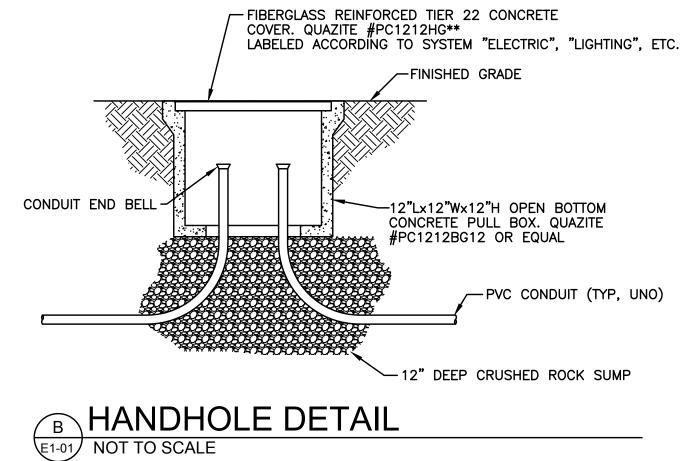

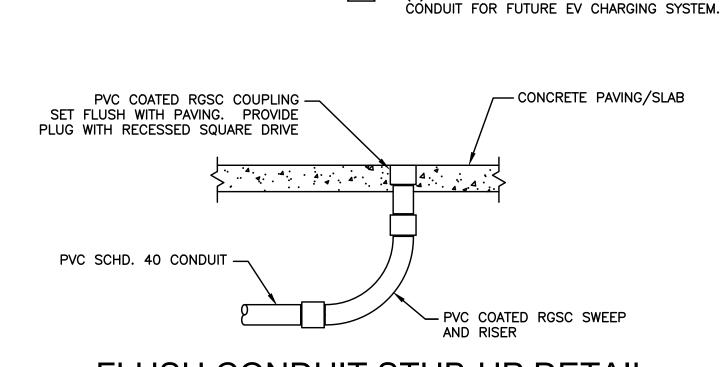

FLUSH CONDUIT STUB-UP DETAIL E1-01 NOT TO SCALE


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**GENERAL NOTES:** 

- A. CONTRACTOR SHALL EXERCISE EXTREME CARE TO MAINTAIN ALL EXISTING UTILITIES WITHOUT INTERRUPTION. CONTRACTOR SHALL IMMEDIATELY REPAIR ANY DAMAGE INADVERTENTLY RENDERED TO EXISTING UTILITIES BY HIS WORK.
- B. REFERENCE CIVIL DRAWINGS FOR OTHER EXISTING UTILITIES NOT SHOWN ON THIS DRAWING. INFORMATION REPRESENTED BETWEEN THIS DRAWING AND CIVIL DRAWINGS IS THE BEST INFORMATION AVAILABLE. HOWEVER, ACCURACY IS NOT GUARANTEED, AND OTHER UTILITIES MAY BE PRESENT BEYOND WHAT ARE SHOWN. CONTRACTOR SHALL BE RESPONSIBLE TO
- C. CONTRACTOR SHALL DAYLIGHT ALL EXISTING UTILITIES BY HAND BEFORE COMMENCING WITH MACHINE
- D. MINIMUM CONDUIT SIZE THIS SHEET SHALL BE 1", ROUTED AT LEAST 24" BFG, UNO.
- F. COORDINATE EXACT LOCATION OF ALL RECEPTACLE PEDESTALS AND LIGHT POLES WITH ARCHITECT PRIOR
- TO ROUGH-IN. G. RE: CONVERGINT DRAWINGS FOR ACCESS CONTROL & CCTV CONDUITS AND ENCLOSURES TO BE PROVIDED UNDER THIS CONTRACT AT GATE OPERATORS, LIGHT
- H. PROVIDE PULL STRINGS IN ALL EMPTY CONDUITS.

### KEYED NOTES:

- 1. NEW PADMOUNT TRANSFORMER. PROVIDE CONCRETE PAD IN ACCORDANCE WITH UTILITY CONSTRUCTION STANDARDS. COORDINATE WITH UTILITY.
- 2. CT ENCLOSURE WITH METER BASE ABOVE INSTALLED PER OGE STANDARDS FOR FLEET BUILDING. RE: SHEET E3-01.
- 3. METER BASE MOUNTED ON UNISTRUT RACK PER OGE STANDARDS FOR PARKS BUILDING.
- /1\ 4. BLOCK HEATER OUTLET PEDESTAL, WITH (2) WR SIMPLEX OUTLETS. RE: DETAIL C THIS SHEET.
- 5. STUB CONDUIT UP FOR FUTURE ELECTRIC VEHICLE CHARGE PEDESTAL. COORDINATE EXACT LOCATION WITH ARCHITECT. RE: DETAIL "D" THIS SHEET.
- HAZARDOUS AREA. RE: SHEET E3-01. 7. STUB-UP AT APPROPRIATE PANEL. COORDINATE WITH HAZARDOUS AREA. RE: SHEET E3-02.
- 8. PROVIDE CONCRETE PAD. RE: STRUCTURAL DRAWINGS. 9. PROVIDE HOT-DIPPED GALVANIZED RACK WITH 36"
- 10. COMMUNICATIONS HANDHOLE. RE: CIVIL
- 11. STUB-UP AT TELEPHONE TERMINAL BOARD. RE: POWER PLANS FOR DETAILS.
- 1 12. 2" EMPTY CONDUIT 36" BFG. STUB INTO PANEL "PMDP" FOR FUTURE EV FEEDER (ALT. NO. 1) 13. PROVIDE GFCI CIRCUIT BREAKERS AS SCHEDULED. 14. MOUNT ON CANOPY COLUMN 48" AFF.
- 15. MINI POWER ZONE PAD MOUNTED. PROVIDE (2) 1" SPARE CONDUITS STUBBED EAST AND CAPPED BELOW PARKING. MARK ENDS IN PAVING. IF WALL-MOUNTED UNIT IS UTILIZED, PROVIDE HOT-DIPPED GALVANIZED RACK WITH 36" DEEP FOOTINGS.
- 16. COORDINATE EXACT LOCATION OF POLE FOUNDATION IN PROXIMITY TO THE BUILDING WITH THE ARCHITECT 17. FUTURE OGE PADMOUNT TRANSFORMER FOR BUS EV CHARGING SYSTEM.
- 18. FUTURE PAD FOR EV CHARGING SYSTEM EQUIPMENT. 19. CAP CONDUITS BELOW GRADE FOR FUTURE EXTENSION AND MARK ENDS WITH REBAR DRIVEN FLUSH WITH GRADE.
- 20.(3) 2" CONDUITS ROUTED 36" BFG TO TOP OF CONDUIT FOR FUTURE EV CHARGING SYSTEM.
- 21. NEMA 3R DISCONNECT SWITCH LOCATED AS DIRECTED BY CNG CONTRACTOR OUTSIDE THE HAZARDOUS AREA. PROVIDE EMERGENCY POWER OFF (EPO) STATION WIRED TO SHUNT-TRIP CIRCUIT BREAKER ON UNISTRUT PEDESTAL WITH CONCRETE FOOTING ADJACENT TO PANEL "SN2A". COORDINATE EXACT EPO LOCATION WITH ARCHITECT.
- 22. MOTORIZED GATE OPERATOR. COORDINATE EXACT POWER AND CONTROL REQUIREMENTS WITH EQUIPMENT PROVIDED. PROVIDE ADDITIONAL CONDUITS AND CIRCUITING AS INDICATED ON CONVERGINT SECURITY PLANS.
- 1 23.1" COMMUNICATIONS CONDUIT STUBBED UP AT CNG PAD PER DETAIL "D", THIS SHEET. ROUTE TO FLEET BUILDING SERVER ROOM WITHOUT ANY HORIZONTAL SWEEPS AND STUB-UP AT TELCO TERMINAL BOARD. COORDINATE EXACT STUB-UP LOCATION WITH CNG CONTRACTOR.
- 24.1" COMMUNICATIONS CONDUIT CAPPED BELOW GRADE AND MARKED. ROUTE TO FLEET BUILDING SERVER ROOM WITHOUT ANY HORIZONTAL SWEEPS AND STUB-UP AT TELCO TERMINAL BOARD.
- 25. TO PANEL INDICATED. RE: ONE-LINE DIAGRAM. 26.1.5" CONTROL CONDUIT WITH CONDUCTORS FOR REMOTE ANNUNCIATOR, REMOTE EPO, AND ENGINE START. WIRE START CIRCUIT FROM BOTH ATS
- 27. CIRCUIT FOR BATTERY CHARGER. 28. CIRCUIT FOR JACKET WATER HEATER.
- 30. PROVIDE 15A, 120V POWER TO CONVERGINT GATE CONTROLLER FROM CONTROL POWER TRANSFORMER. PROVIDE 2KVA 480-120V TRANSFORMER WITH PRIMARY AND SECONDARY FUSES MOUNTED INSIDE GATE CONTROLLER HOUSING. COORDINATE WITH GATE CONTROLLER MANUFACTURER.
- 31. PROVIDE TRANSFORMER BASE TO MATCH POLE AND 1KVA WEATHERPROOF 277-120V, CONTROL POWER TRANSFORMER WITH PRIMARY AND SECONDARY FUSES FOR CCTV CAMERA. RE: CONVERGINT DRAWINGS FOR
- ADDITIONAL REQUIREMENTS. 1 32. FIXTURE LOCATED BETWEEN PARKING SPACES SUSPENDED 6" BELOW ROOF DECK.
- 4 33.(2) 4" CONDUITS ROUTED 36" BFG TO TOP OF

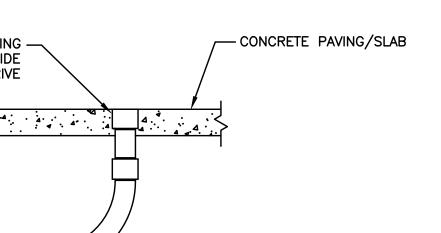

OWNER CITY OF NORMAN, OKLAHOMA 201 A WEST GRAY STREET NORMAN, OKLAHOMA 73069 (405) 366-5406 www.NormanOK.gov

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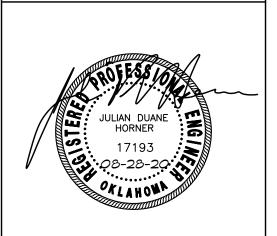
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REVISIONS DATE DESCRIPTION 1 09/18/20 ADD. NO. 2

11/24/20 EV MODIFICATIONS

GSB PROJECT NO.

DRAWING TITLE ELECTRICAL SITE PLAN

191650

DATE 08/28/2020

DRAWING NO.

E1-01

### Change Order No. One to Contract K-2021-35



Jason Lohaus - Estimator turningpoint.lohaus@gmail.com

Cell: 405-255-3395 Office: 405-579-7663 Fax: 405-579-1693

Federal ID: 71-0913108

PO Box 1805 | Blanchard OK 73010

December 06, 2020

**RE: Norman North Base Complex** 


#### **REVISION 4 CHANGES:**

- Add mechanical pads for EV stations
- Add bollards adjacent to EV stations and transformer
- Add EV pavement markings (will need detail provided prior to placement)

#### ITEMIZED AS FOLLOWS:

DESCRIPTION:	QTY:	UNIT:	<b>UNIT COST:</b>	SUB:
5-6" NR Mechanical Pad placed on grade	3.00	EA	600.00	1800.00
4" Bollards (Type I) (Labor Only)	23.00	EA	180.00	4140.00
EV Pavement Stencils	3.00	EA	60.00	180.00
TOTAL:				<i>-</i> \$ <del>6,120.00</del>

Note: Per previous correspondence the materials, labor and installation of the mechanical pads and bollards for the EV stations and transformer are the responsibility of the EV contractor.

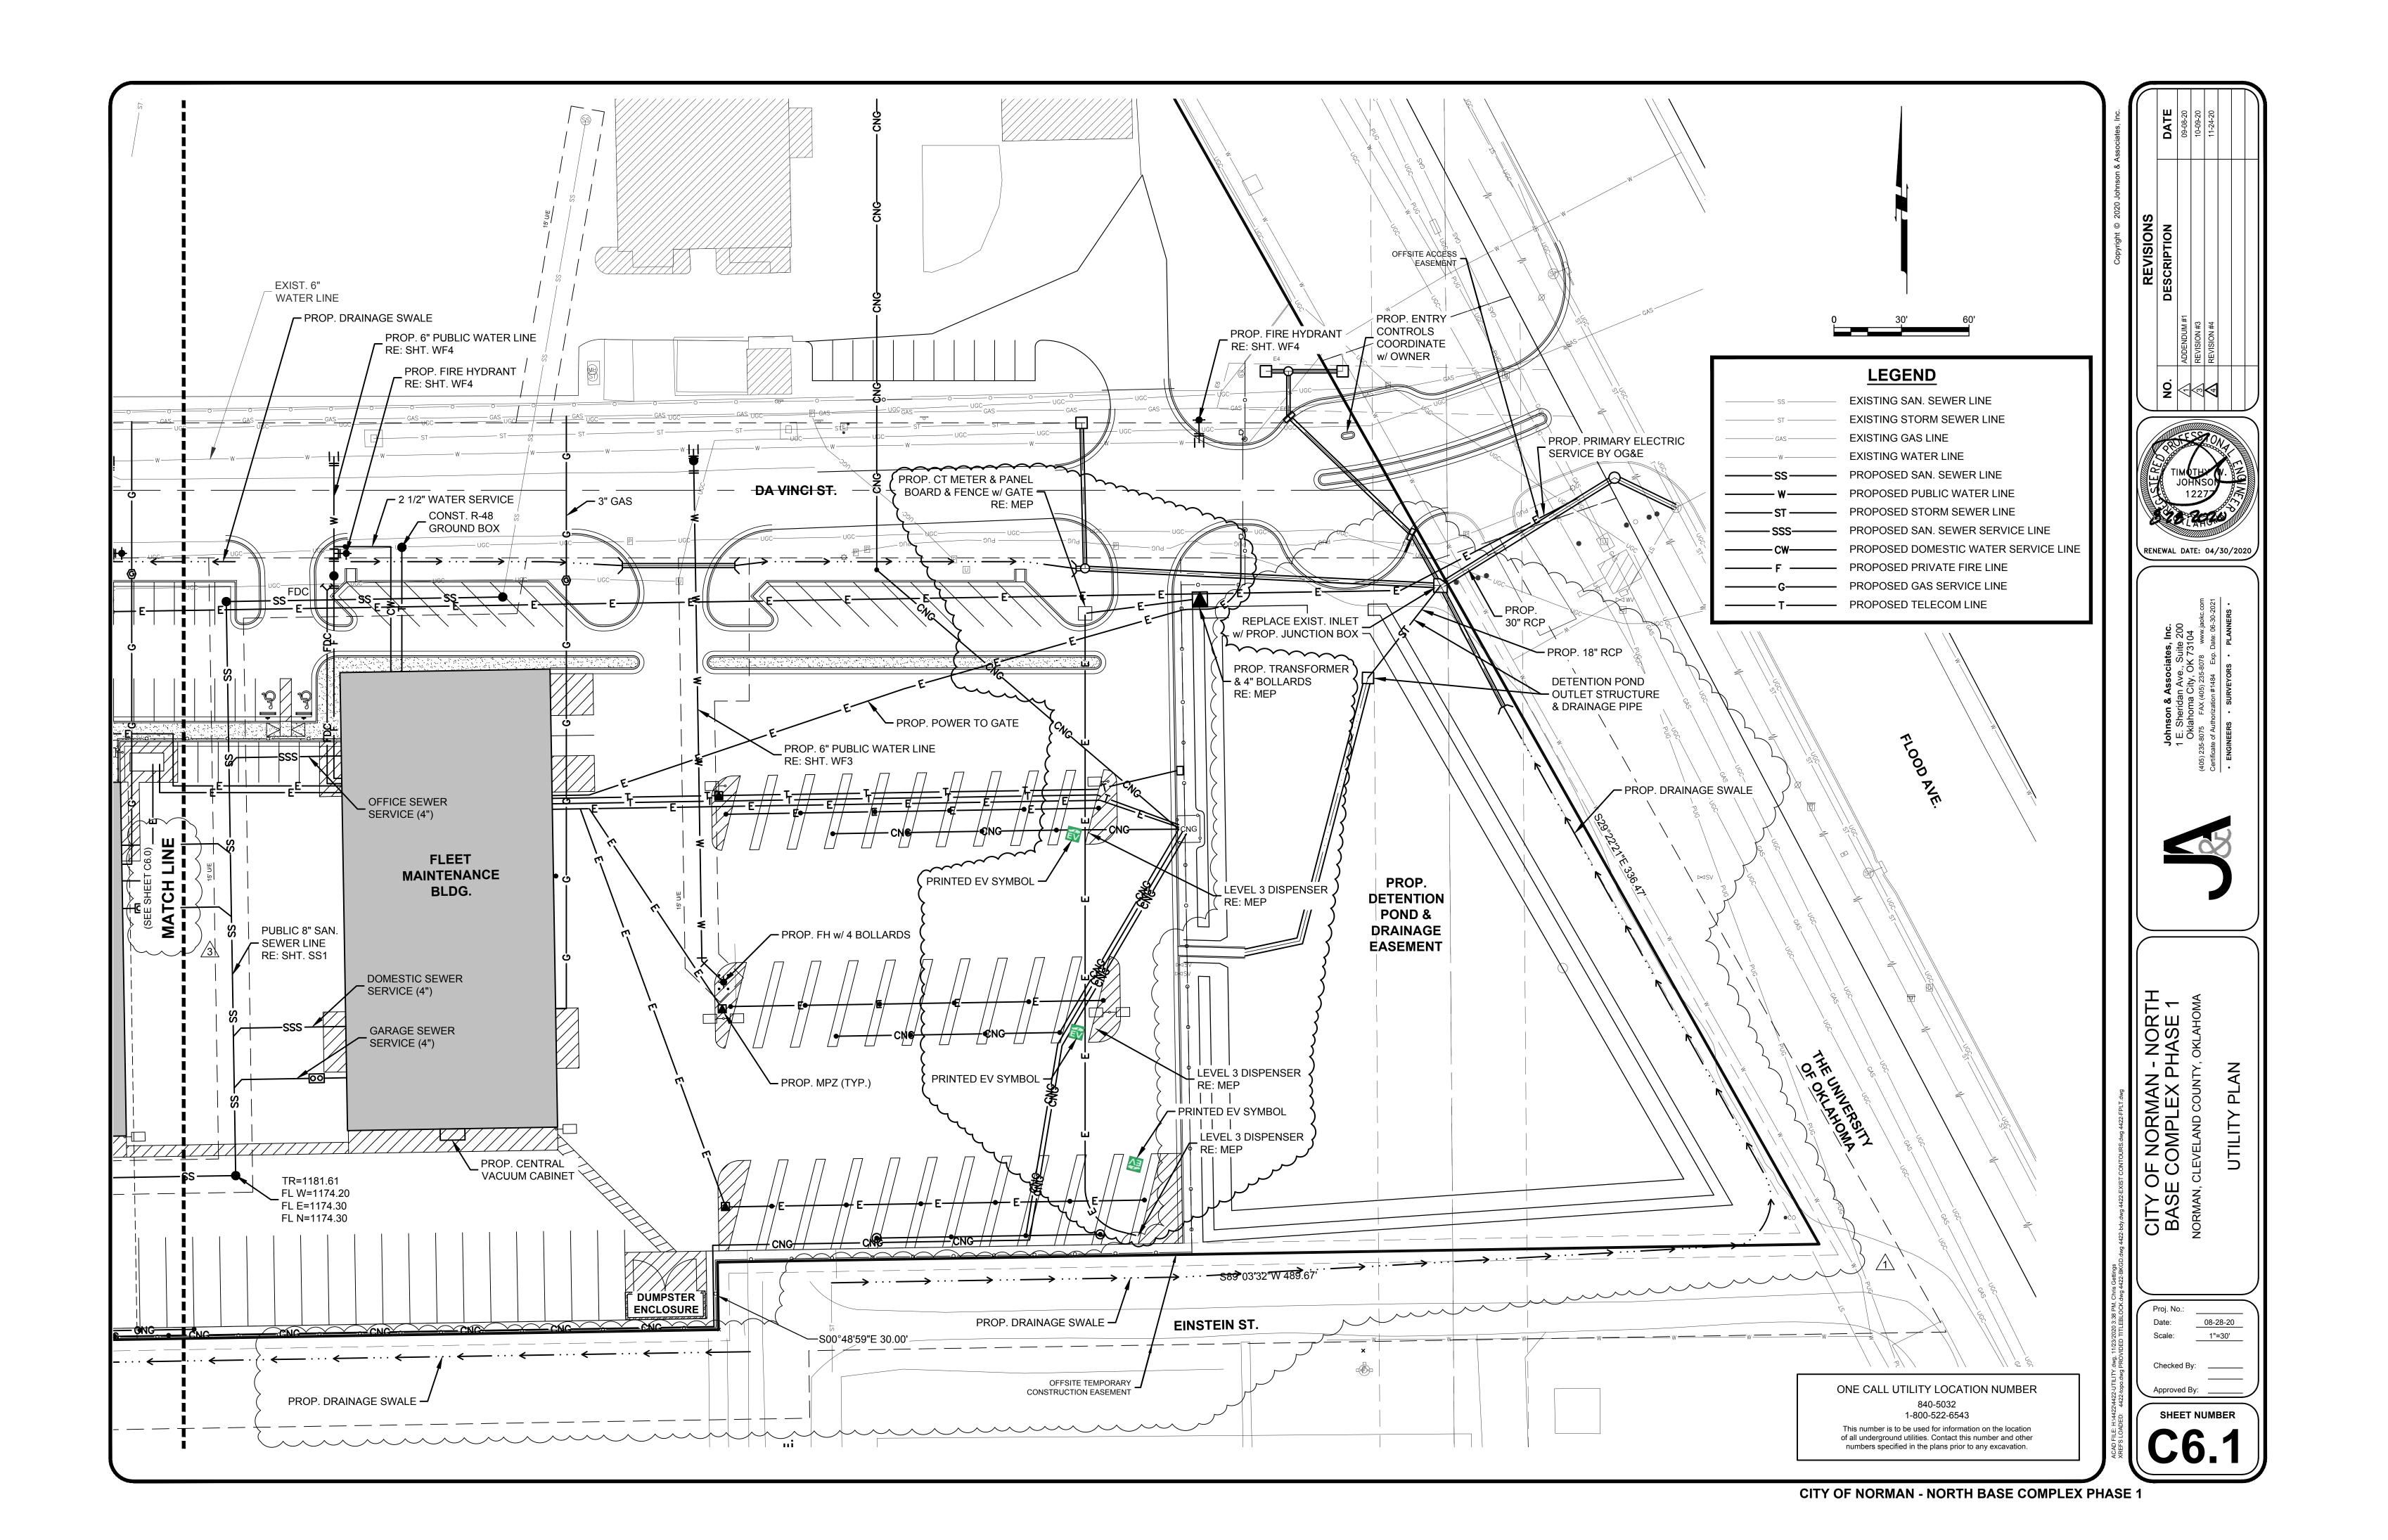



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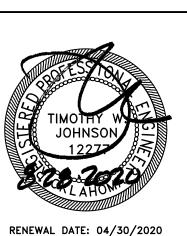
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	REV	ISIONS
NO.	DATE	DESCRIPTION


GSB PROJECT NO.

DRAWING TITLE UTILITY PLAN

08-28-20

DRAWING NO.

# Change Order No. One to K-2021-2

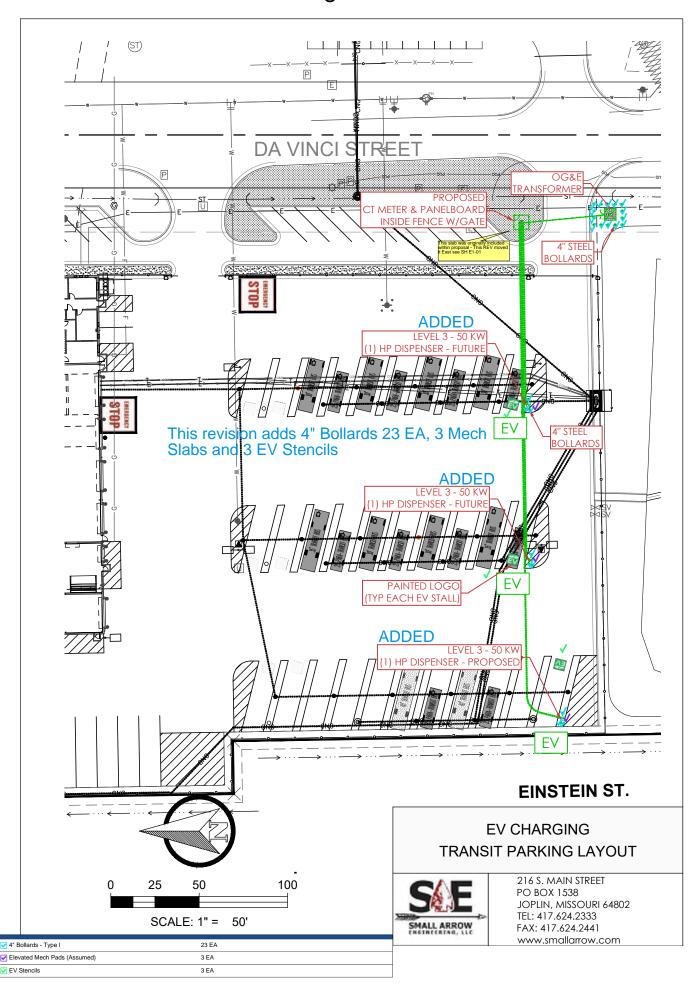


## H & H Plumbing & Utilities, Inc.

Lic. No. OK 02653 381 W. Adkins Hill Road, Norman, OK 73072-9218 (405) 288-2346 (405) 288-2349 FAX

Sheet (2) of (3)

Contractor: Ph.#:			Project: North Base Complex Phase						
Address:		Fax #:			10 - 1380 Da Vind				
		Email:		No	rman, OK 7307	1			
Private S	Storm Original Price								
ITEM#	ITEM		UNIT	Qty	PRICE	TOTAL			
1	22" x 13 1/2" RCPA headwall		EA	4	2,050.00	8,200.00			
2	24" RCP headwall		EA	1	1,250.00	1,250.00			
3	18" RCP headwall		EA	1	950.00	950.00			
						10,400.00			
Private S	Storm Original Price								
ITEM#	ITEM		UNIT	Qty	PRICE	TOTAL			
1	22" x 13 1/2" RCPA headwall		EA	4	2,550.00	10,200.00			
2	24" RCP headwall		EA	1	2,250.00	2,250.00			
3	18" RCP headwall		EA	1	1,800.00	1,800.00			
						14,250.00			
Added Pi	ipe & Structure								
ITEM#	ITEM		UNIT	Qty	PRICE	TOTAL			
1	30" RCP storm pipe		LF	11	70.00	770.00			
2 3	5' Dia. Manhole		EA	1	2,850.00	2,850.00			
						3,620.00			
Public W									
ITEM#	ITEM		UNIT	Qty	PRICE	TOTAL			
5	6" Gate valve & box		EA	4	980.00	3,920.00			
						3,920.00			
				Contract /	Amount \$	11,390.00			
Submitted	d By: Jason Lawrance	Т	itle: Project M	lanager	Date:	11/30/2020			
Accepted	Bv <sup>.</sup>	Т	itle·		Date:				

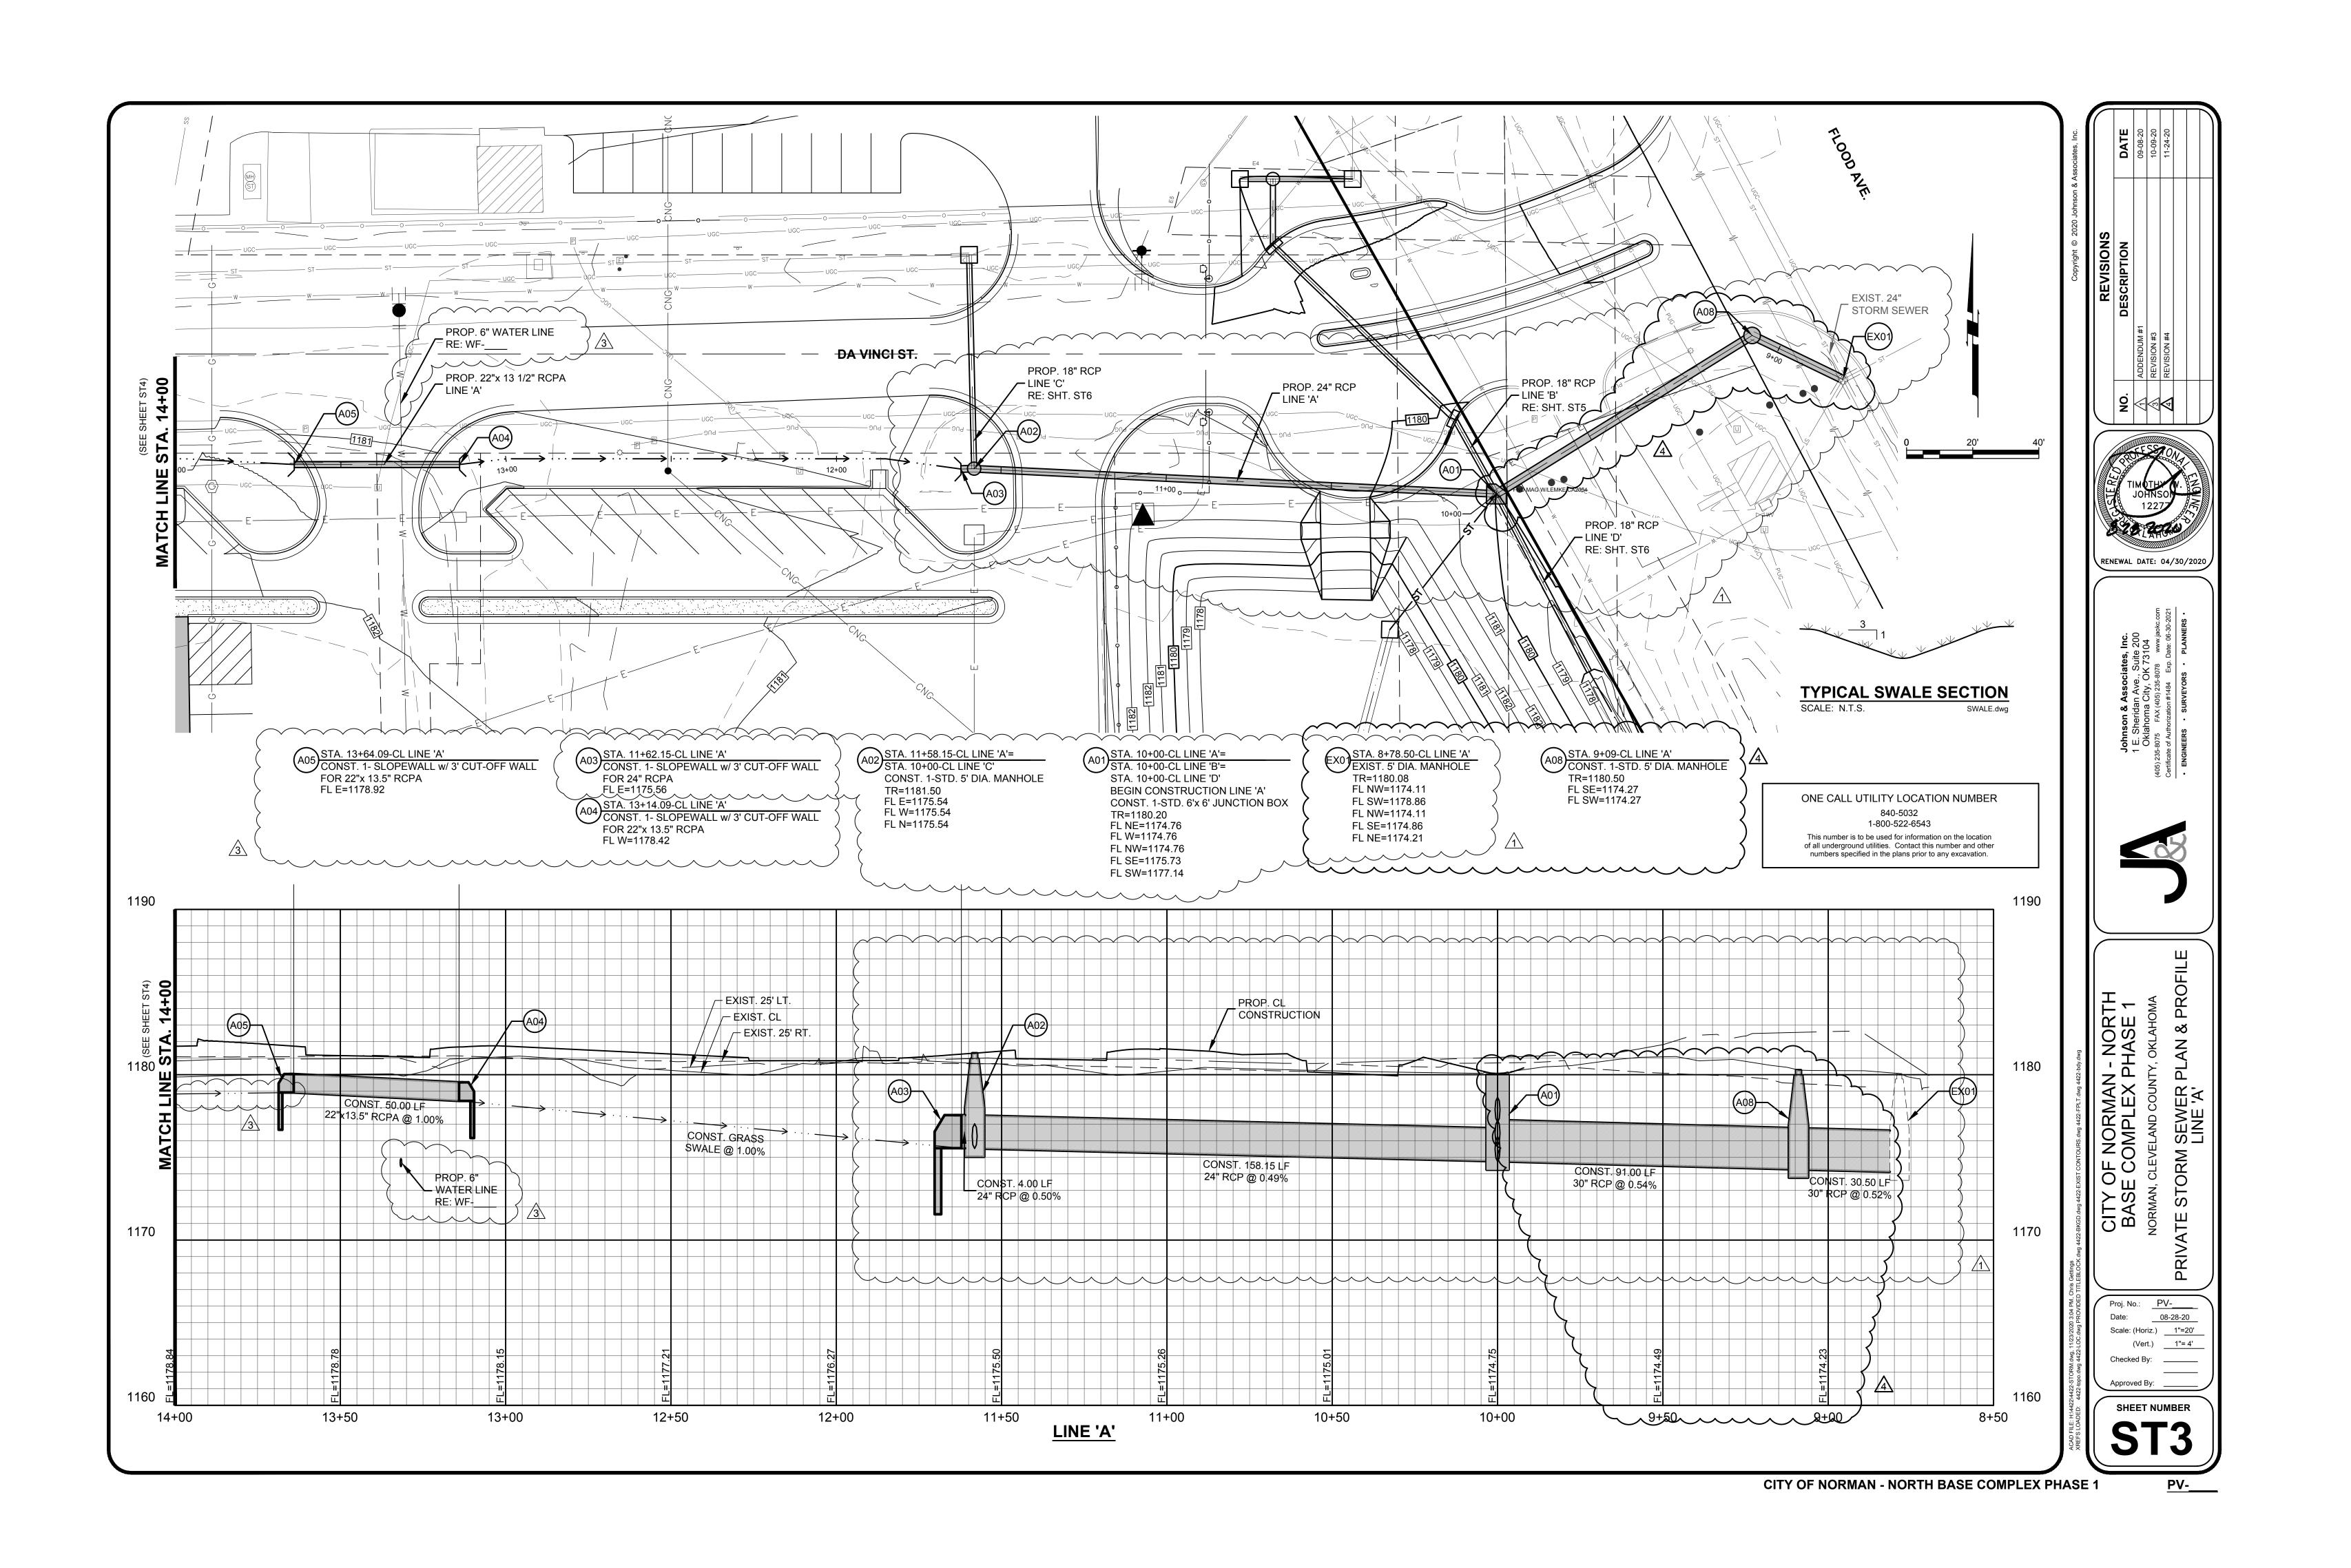



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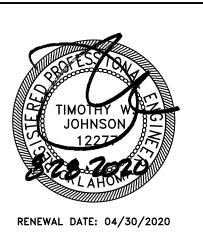
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REVISIONS NO. DATE DESCRIPTION

GSB PROJECT NO.

191650 DRAWING TITLE

PRIVATE STORM SEWER PLAN & PROFILE

DRAWING NO.

# **REVISION 5**

#### DSE Bidding and Estimating Form

Job: NORTH BASE

Page #


1

Area: REV 5

Enter E, C or W in Unit Labor

tem	Qty	Unit	Description	Hours	Ext	Material	Ext	Open	Ext
1			added (2) runs of 1.25" pvc at 320' ea.						
2									
3	64	6	10' sticks of 1,25" PVC			16.00	1024.00		
4	4	6	1.25" rob roy 90"s			25.00	100.00		
5	8	e	8 hours labor 2 men labor	2	16.00				
6									
7									
8									
9									
10									
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27									
28									
29									
30									
31									
32									

Labor Hour Rate 60 Total Labor 960
Total Material 1,293
Total Page 1 Profit 15.00% Total Opening 0
Total 2,253

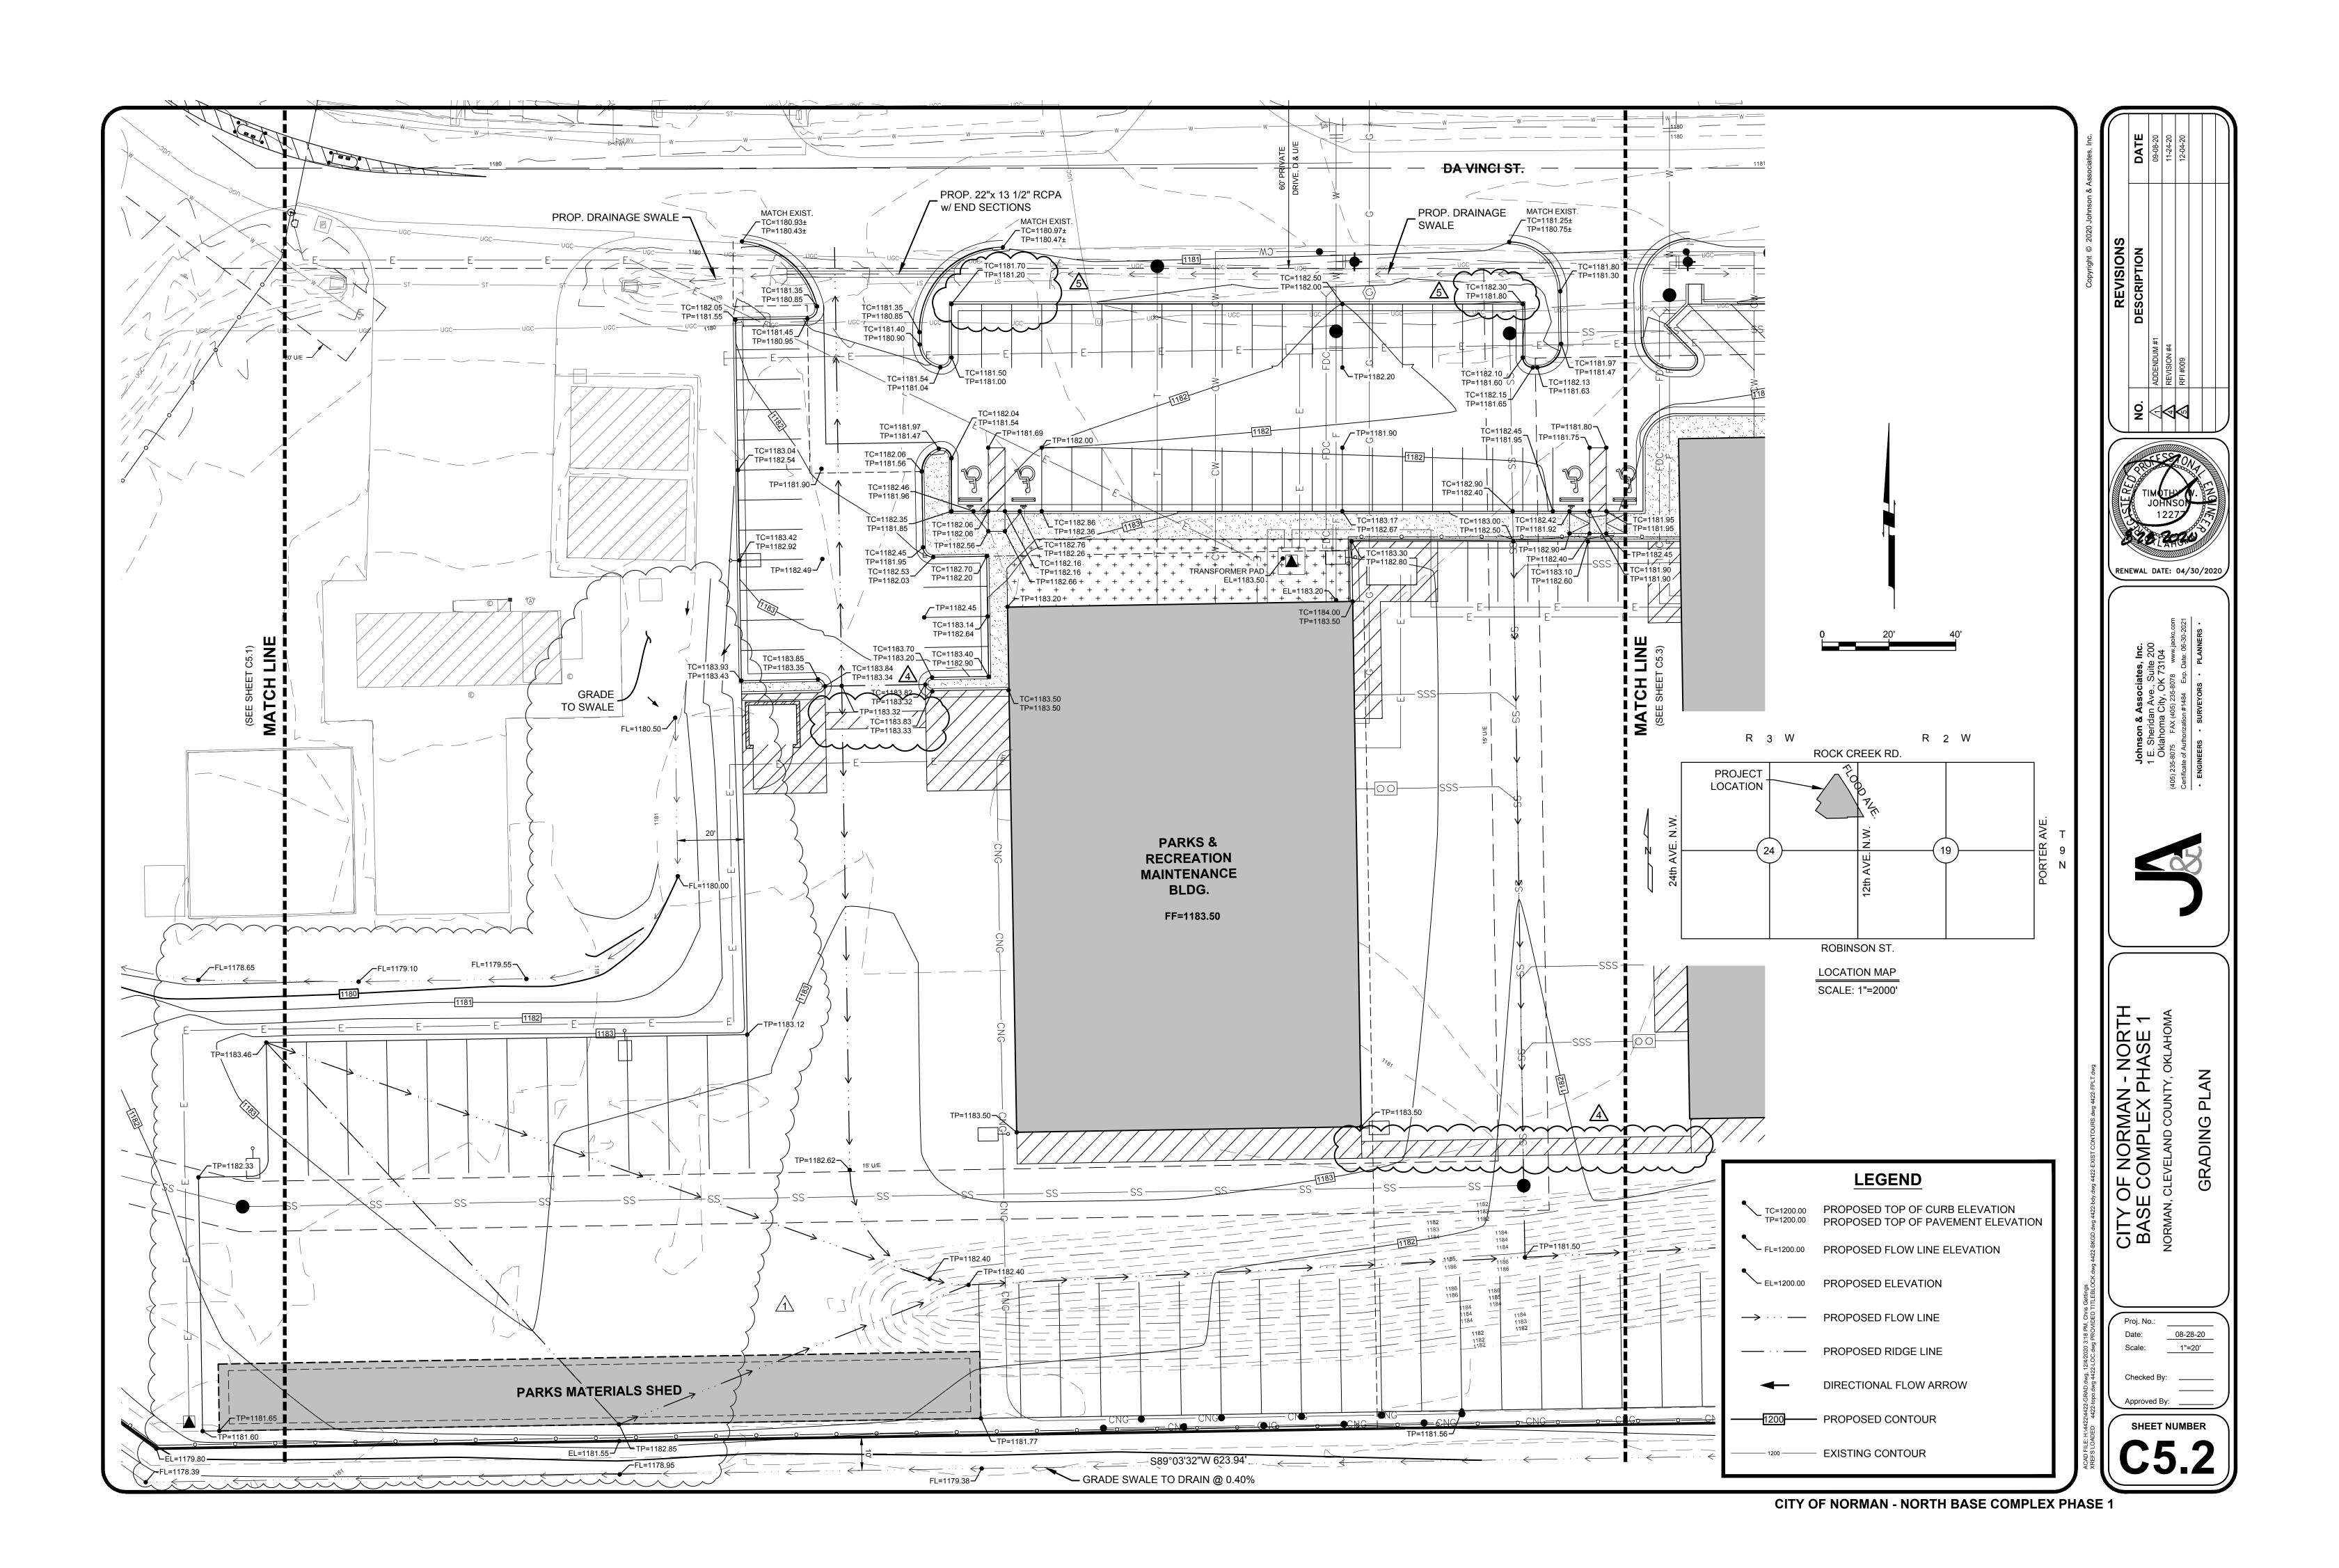



ARCHITECT GSB, INC 3555 NW 58th Street, Suite 700W Oklahoma City, OK 73112 (405) 848-9549

www/gsb-inc.com CIVIL ENGINEER JOHNSON & ASSOCIATES 1 EAST SHERIDAN AVE.- STE. 200 OKLAHOMA CITY, OKLAHOMA 73104

(405) 235-8075 www.jaokc.com STRUCTURAL ENGINEER WALLACE ENGINEERING 410 NORTH WALNUT AVE. - STE. 200 OKLAHOMA CITY, OK 73104 (405) 236-5858

www.wallacesc.com M/ P/ FP ENGINEER ALLEN CONSULTING, INC. 110 NORTH MERCEDES DRIVE NORMAN, OK 73069


(405) 928-7702 www.acimep.com ELECTRICAL ENGINEER 1306 COMMERCE DRIVE

HORNER ASSOCIATES ENGINEERS NORMAN, OKLAHOMA 73071 (405) 801-2528 www.haeinc.com

LANDSCAPE ARCHITECT PLANNING DESIGN GROUP 5314 SOUTH YALE AVE - STE. 510 TULSA, OKLAHOMA 74135 (918) 628-1255

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REVISIONS DATE DESCRIPTION


GSB PROJECT NO.

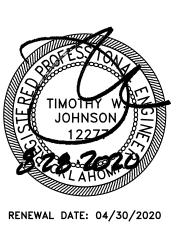DRAWING TITLE GRADING PLAN

08-28-20

DRAWING NO.

C5.2

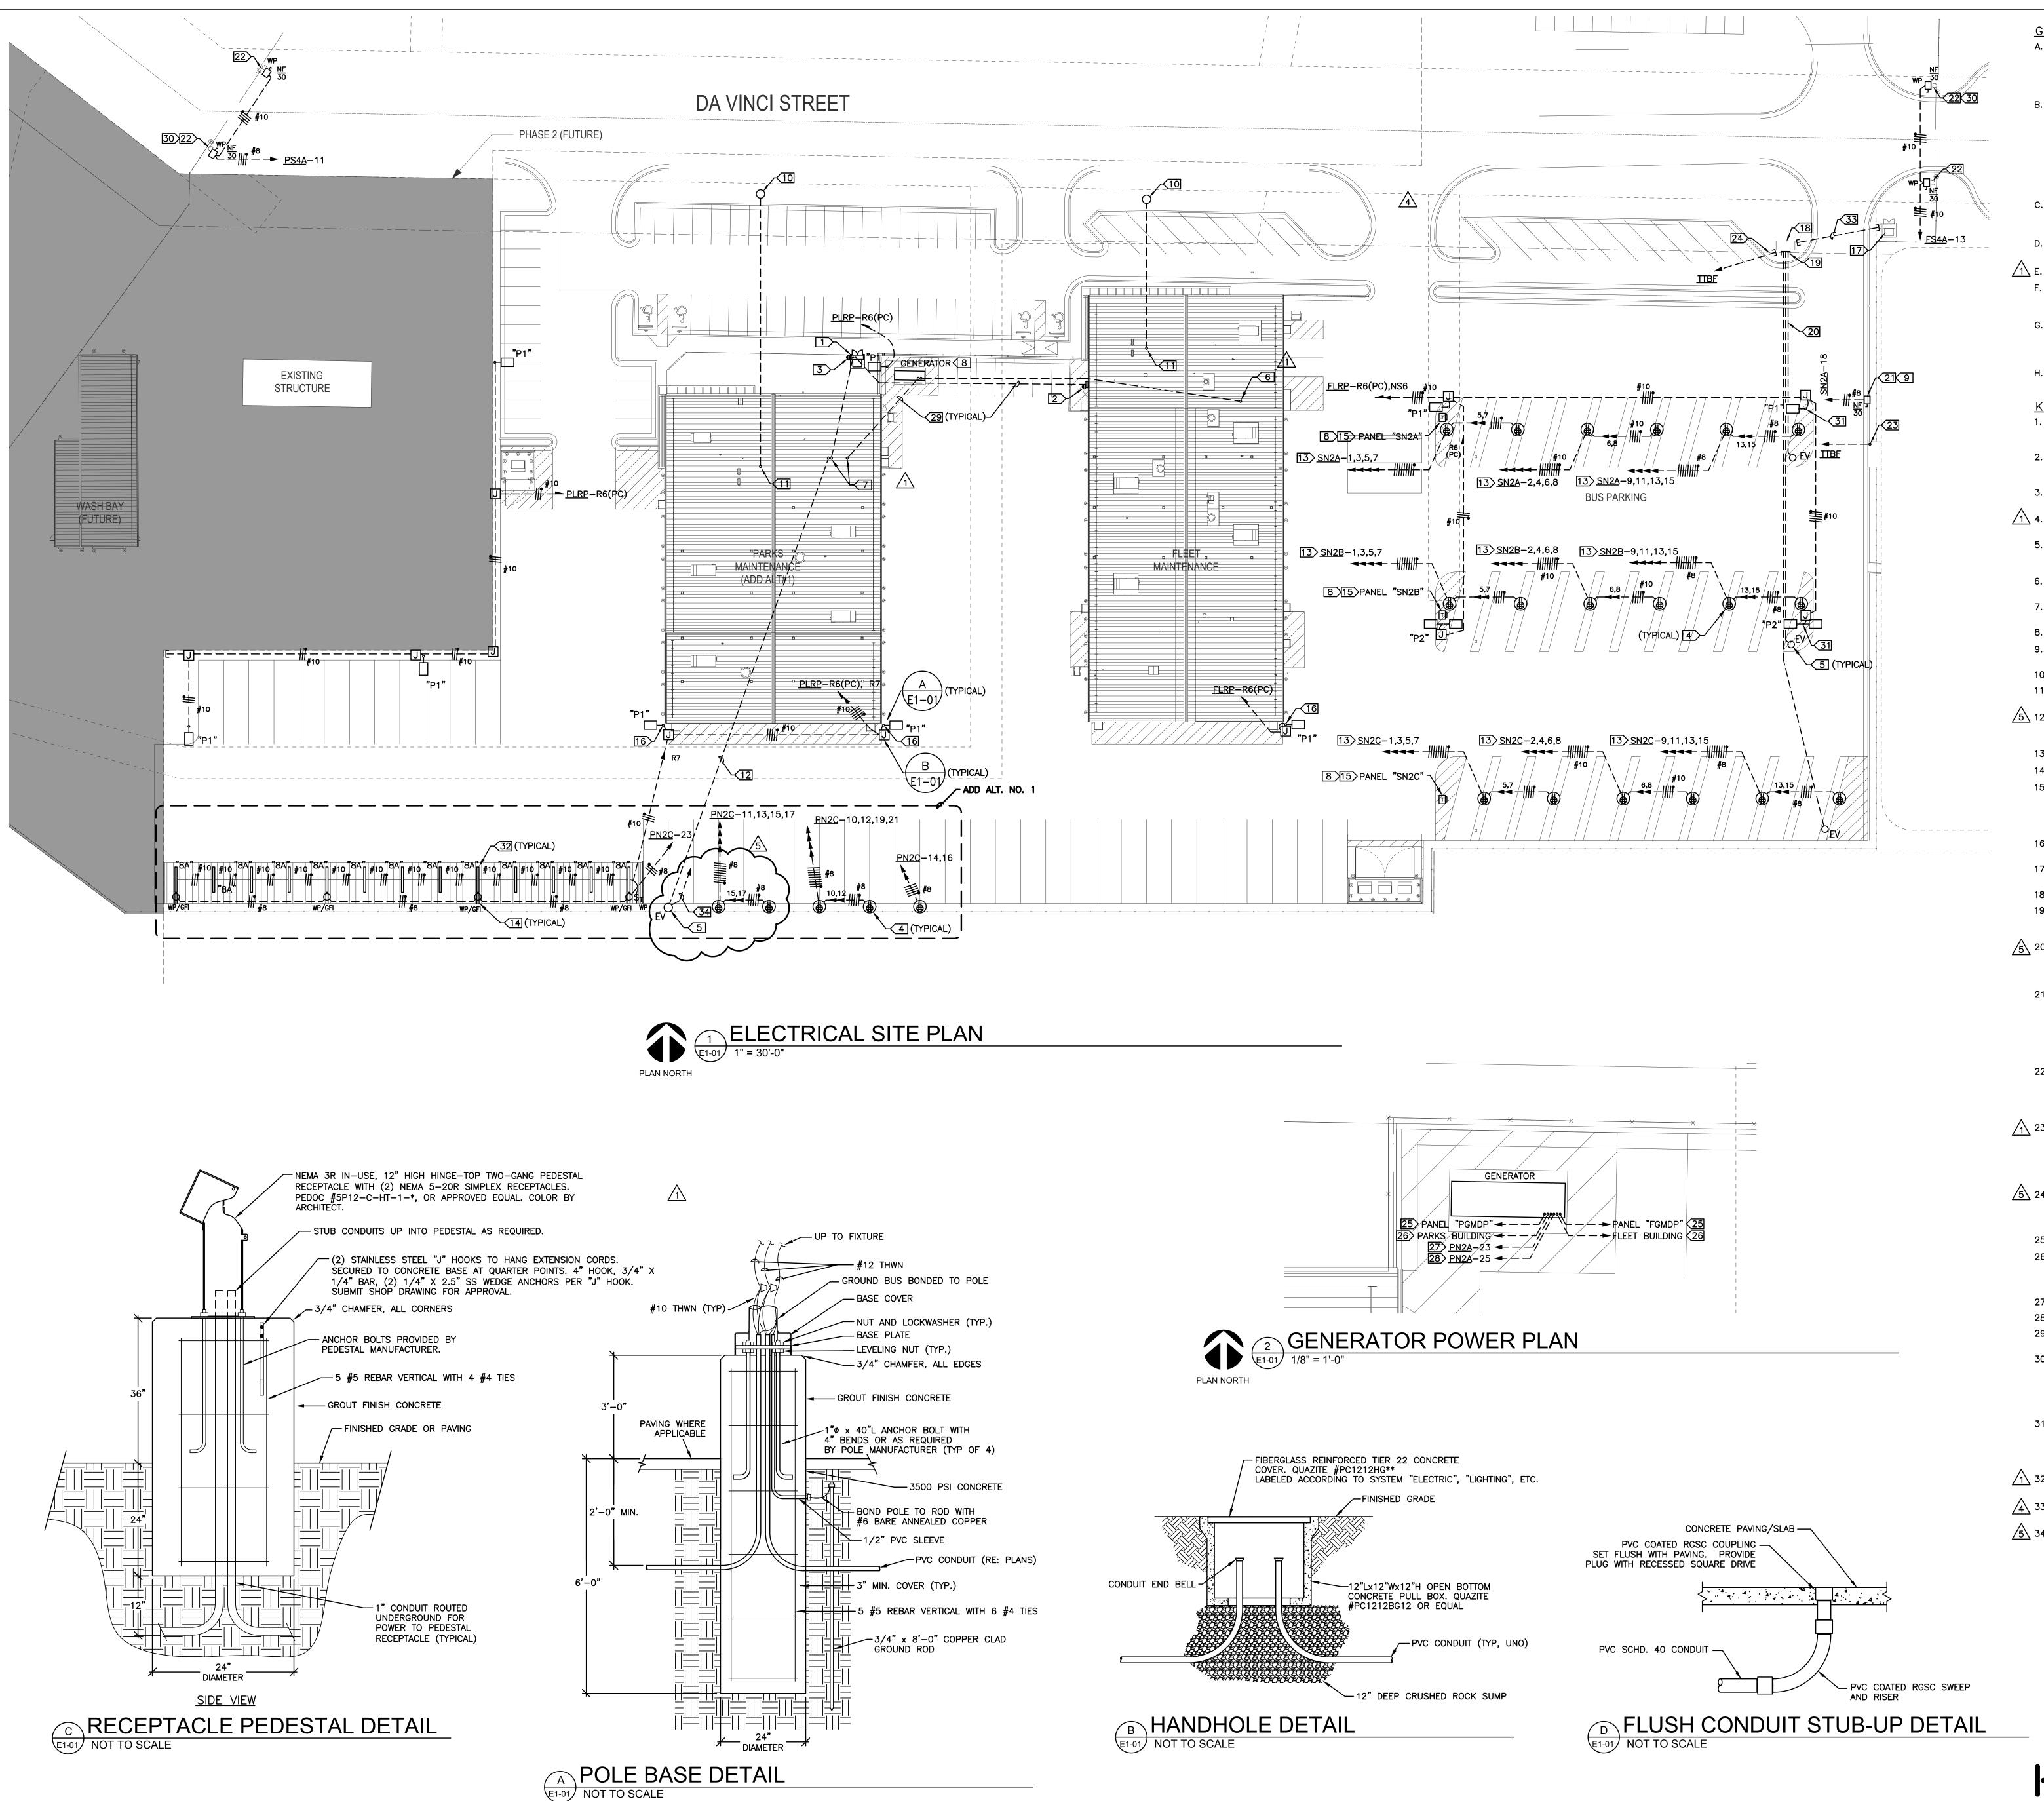

**GENERAL NOTES:** 

- A. CONTRACTOR SHALL EXERCISE EXTREME CARE TO MAINTAIN ALL EXISTING UTILITIES WITHOUT INTERRUPTION. CONTRACTOR SHALL IMMEDIATELY REPAIR ANY DAMAGE INADVERTENTLY RENDERED TO EXISTING UTILITIES BY HIS WORK.
- B. REFERENCE CIVIL DRAWINGS FOR OTHER EXISTING UTILITIES NOT SHOWN ON THIS DRAWING. INFORMATION REPRESENTED BETWEEN THIS DRAWING AND CIVIL DRAWINGS IS THE BEST INFORMATION AVAILABLE. HOWEVER, ACCURACY IS NOT GUARANTEED, AND OTHER UTILITIES MAY BE PRESENT BEYOND WHAT ARE SHOWN. CONTRACTOR SHALL BE RESPONSIBLE TO MAINTAIN AND PROTECT ALL UTILITIES WHETHER SHOWN OR NOT.
- C. CONTRACTOR SHALL DAYLIGHT ALL EXISTING UTILITIES BY HAND BEFORE COMMENCING WITH MACHINE
- DIGGING. D. MINIMUM CONDUIT SIZE THIS SHEET SHALL BE 1",
- ROUTED AT LEAST 24" BFG, UNO. /1 E. NOT USED. F. COORDINATE EXACT LOCATION OF ALL RECEPTACLE
- PEDESTALS AND LIGHT POLES WITH ARCHITECT PRIOR TO ROUGH-IN. G. RE: CONVERGINT DRAWINGS FOR ACCESS CONTROL &

CCTV CONDUITS AND ENCLOSURES TO BE PROVIDED

UNDER THIS CONTRACT AT GATE OPERATORS, LIGHT

POLES, ETC. H. PROVIDE PULL STRINGS IN ALL EMPTY CONDUITS.

### KEYED NOTES:

- 1. NEW PADMOUNT TRANSFORMER. PROVIDE CONCRETE PAD IN ACCORDANCE WITH UTILITY CONSTRUCTION STANDARDS. COORDINATE WITH UTILITY.
- 2. CT ENCLOSURE WITH METER BASE ABOVE INSTALLED PER OGE STANDARDS FOR FLEET BUILDING. RE: SHEET E3-01.
- 3. METER BASE MOUNTED ON UNISTRUT RACK PER OGE STANDARDS FOR PARKS BUILDING.
- /1\ 4. BLOCK HEATER OUTLET PEDESTAL, WITH (2) WR SIMPLEX OUTLETS. RE: DETAIL C THIS SHEÉT.
- 5. STUB CONDUIT UP FOR FUTURE ELECTRIC VEHICLE CHARGE PEDESTAL. COORDINATE EXACT LOCATION WITH ARCHITECT. RE: DETAIL "D" THIS SHEET.
- 6. STUB-UP AT APPROPRIATE PANEL. COORDINATE WITH HAZARDOUS AREA. RE: SHEET E3-01. 7. STUB-UP AT APPROPRIATE PANEL. COORDINATE WITH
- HAZARDOUS AREA. RE: SHEET E3-02. 8. PROVIDE CONCRETE PAD. RE: STRUCTURAL DRAWINGS. 9. PROVIDE HOT-DIPPED GALVANIZED RACK WITH 36"
- DEEP FOOTINGS. 10. COMMUNICATIONS HANDHOLE. RE: CIVIL
- 11. STUB-UP AT TELEPHONE TERMINAL BOARD. RE: POWER PLANS FOR DETAILS.  $\sqrt{5}$  12. (2) 2" EMPTY CONDUITS WITH PULL ROPES ROUTED
- 36" BFG. STUB CONDUITS INTO PANEL "PMDP" FOR FUTURE EV FEEDERS.
- 13. PROVIDE GFCI CIRCUIT BREAKERS AS SCHEDULED. 14. MOUNT ON CANOPY COLUMN 48" AFF.
- 15. MINI POWER ZONE PAD MOUNTED. PROVIDE (2) 1" SPARE CONDUITS STUBBED EAST AND CAPPED BELOW PARKING. MARK ENDS IN PAVING. IF WALL-MOUNTED UNIT IS UTILIZED, PROVIDE HOT-DIPPED GALVANIZED RACK WITH 36" DEEP FOOTINGS.
- 16. COORDINATE EXACT LOCATION OF POLE FOUNDATION IN PROXIMITY TO THE BUILDING WITH THE ARCHITECT 17. FUTURE OGE PADMOUNT TRANSFORMER FOR BUS EV CHARGING SYSTEM. 18. FUTURE PAD FOR EV CHARGING SYSTEM EQUIPMENT.
- 19. CAP CONDUITS BELOW GRADE FOR FUTURE EXTENSION AND MARK ENDS WITH REBAR DRIVEN FLUSH WITH GRADE.
- 20.(3) 3" AND (3) 1.25" CONDUITS WITH PULL ROPES ROUTED 36" BFG TO TOP OF CONDUIT FOR FUTURE EV CHARGING SYSTEM. ROUTE (1) 3" AND (1) 1.25' TO EACH EV CHARGE PEDESTAL.
- 21. NEMA 3R DISCONNECT SWITCH LOCATED AS DIRECTED BY CNG CONTRACTOR OUTSIDE THE HAZARDOUS AREA. PROVIDE EMERGENCY POWER OFF (EPO) STATION WIRED TO SHUNT-TRIP CIRCUIT BREAKER ON UNISTRUT PEDESTAL WITH CONCRETE FOOTING ADJACENT TO PANEL "SN2A". COORDINATE EXACT EPO LOCATION WITH ARCHITECT.
- 22. MOTORIZED GATE OPERATOR. COORDINATE EXACT POWER AND CONTROL REQUIREMENTS WITH EQUIPMENT PROVIDED. PROVIDE ADDITIONAL CONDUITS AND CIRCUITING AS INDICATED ON CONVERGINT SECURITY PLANS.
- 23.1" COMMUNICATIONS CONDUIT STUBBED UP AT CNG PAD PER DETAIL "D", THIS SHEET. ROUTE TO FLEET BUILDING SERVER ROOM WITHOUT ANY HORIZONTAL SWEEPS AND STUB-UP AT TELCO TERMINAL BOARD. COORDINATE EXACT STUB-UP LOCATION WITH CNG CONTRACTOR.
- 5 24. (2) 1.25" CONDUITS WITH PULL STRINGS CAPPED BELOW GRADE AND MARKED. ROUTE TO FLEET BUILDING. COORDINATE STUB-UP LOCATIONS WITH OWNER AND EV EQUIPMENT SUPPLIER. 25. TO PANEL INDICATED. RE: ONE-LINE DIAGRAM.
- 26.1.5" CONTROL CONDUIT WITH CONDUCTORS FOR REMOTE ANNUNCIATOR, REMOTE EPO, AND ENGINE START. WIRE START CIRCUIT FROM BOTH ATS SWITCHES.
- 27. CIRCUIT FOR BATTERY CHARGER. 28. CIRCUIT FOR JACKET WATER HEATER. 29. FEEDER AND SERVICE CONDUITS. RE: ONE-LINE
- 30. PROVIDE 15A, 120V POWER TO CONVERGINT GATE CONTROLLER FROM CONTROL POWER TRANSFORMER. PROVIDE 2KVA 480-120V TRANSFORMER WITH PRIMARY AND SECONDARY FUSES MOUNTED INSIDE GATE CONTROLLER HOUSING. COORDINATE WITH GATE CONTROLLER MANUFACTURER.
- 31. PROVIDE TRANSFORMER BASE TO MATCH POLE AND 1KVA WEATHERPROOF 277-120V, CONTROL POWER TRANSFORMER WITH PRIMARY AND SECONDARY FUSES FOR CCTV CAMERA. RE: CONVERGINT DRAWINGS FOR ADDITIONAL REQUIREMENTS.
- 1 32. FIXTURE LOCATED BETWEEN PARKING SPACES SUSPENDED 6" BELOW ROOF DECK.
- 4 33.(2) 4" CONDUITS ROUTED 36" BFG TO TOP OF
- CONDUIT FOR FUTURE EV CHARGING SYSTEM. 5 34. (2) 1.25" COMMUNICATIONS CONDUITS WITH PULL STRINGS ROUTED TO PARKS BUILDING. COORDINATE

STUB-UP LOCATIONS WITH EV EQUIPMENT SUPPLIER.

1306 Commerce Dr, Norman, OK 73071 Certificate of Authorization No. CA 3520, Expires 6/30/2021

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DATE Horner Associates Engineers, Inc.

E1-01

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PLANNING DESIGN GROUP 5314 SOUTH YALE AVE - STE. 510 TULSA, OKLAHOMA 74135 (918) 628-1255 www.planningdesigngroup.com

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REVISIONS DATE DESCRIPTION 1 09/18/20 ADD. NO. 2 11/24/20 EV MODIFICATIONS

5 12/10/20 CNG/EV MODS

GSB PROJECT NO. 191650

DRAWING TITLE ELECTRICAL SITE PLAN

08/28/2020

DRAWING NO.

#### PROPOSED CHANGE ORDER SUMMARY

SUBCONTRACTOR WORK or

X CONSTRUCTION MANAGER SELF PERFORMED WORK

Subcontractor Name (if applicable):

Oakridge Builders a Division of Flintco, LLC/4G Concrete, Inc.


#### THE CITY OF NORMAN

Project Name/#: Norman North Base - Phase 1 20136 (Main Job)

CE No: #001

CE Title: Revision 5 - Foundation Changes
CE Date: 1/21/2021

<u>PCOR</u>			Labor		<u>Material</u>		<u>Equipment</u>			Sul	bcontract
Item No	Description	Hours	Costs				Type Cost			Cost	
1	Direct Labor	38 (@\$45hr)	\$	1,710.00						\$	1,710.00
2	Direct Materials (Rebar & Concrete)				\$	4,416.75				\$	4,416.75
	Direct Subcontracts (Spoils Removal)						Dump Truck	\$	1,083.00	\$	1,083.00
4	Supervision/Safety		\$	164.00			•			\$	164.00
	Expendable Small Tools						Expendable Tools	\$	128.00	\$	128.00
	Experiments critical recis						Experiousie 1996	_	120.00	_	120.00
Subtotals			\$	1,874.00	\$	4,416.75		\$	1,211.00	\$	7,501.75
Labor Bu	ırden (@ 58%)		\$	1,086.92							
Tetal Day			Φ.	0.500.67							
Total Ra	w Cosis		\$	8,588.67							
Overhea	d *		\$	644.15	644.15 * Sum of Overhead + Profit limited to ≤ 15% of						
Profit *		\$		644.15	Tota	al Raw Costs	(by contract)				
0.1	and the land of the same of th										
	ractor's Insurance (applies to subco		\$	-			amount here if CM Self F				
Subconti	ractor's Bonds (applies to subcontrac	ctor work only)	\$	-	← do r	not include an	amount here if CM Self F	'ertorm	ed Work		
Total for S	ubcontractor or CM Solf Borfe	ormod Work	\$	9,876.97	of C	M Proposed C	ork, enter total in Section 1 Change Order Summary fo	rm.			
TOTAL TOT SI	ubcontractor or CM Self-Perfo	onneu vvork	₽	3,010.31			ied work, enter total in Sec Change Order Summary F				

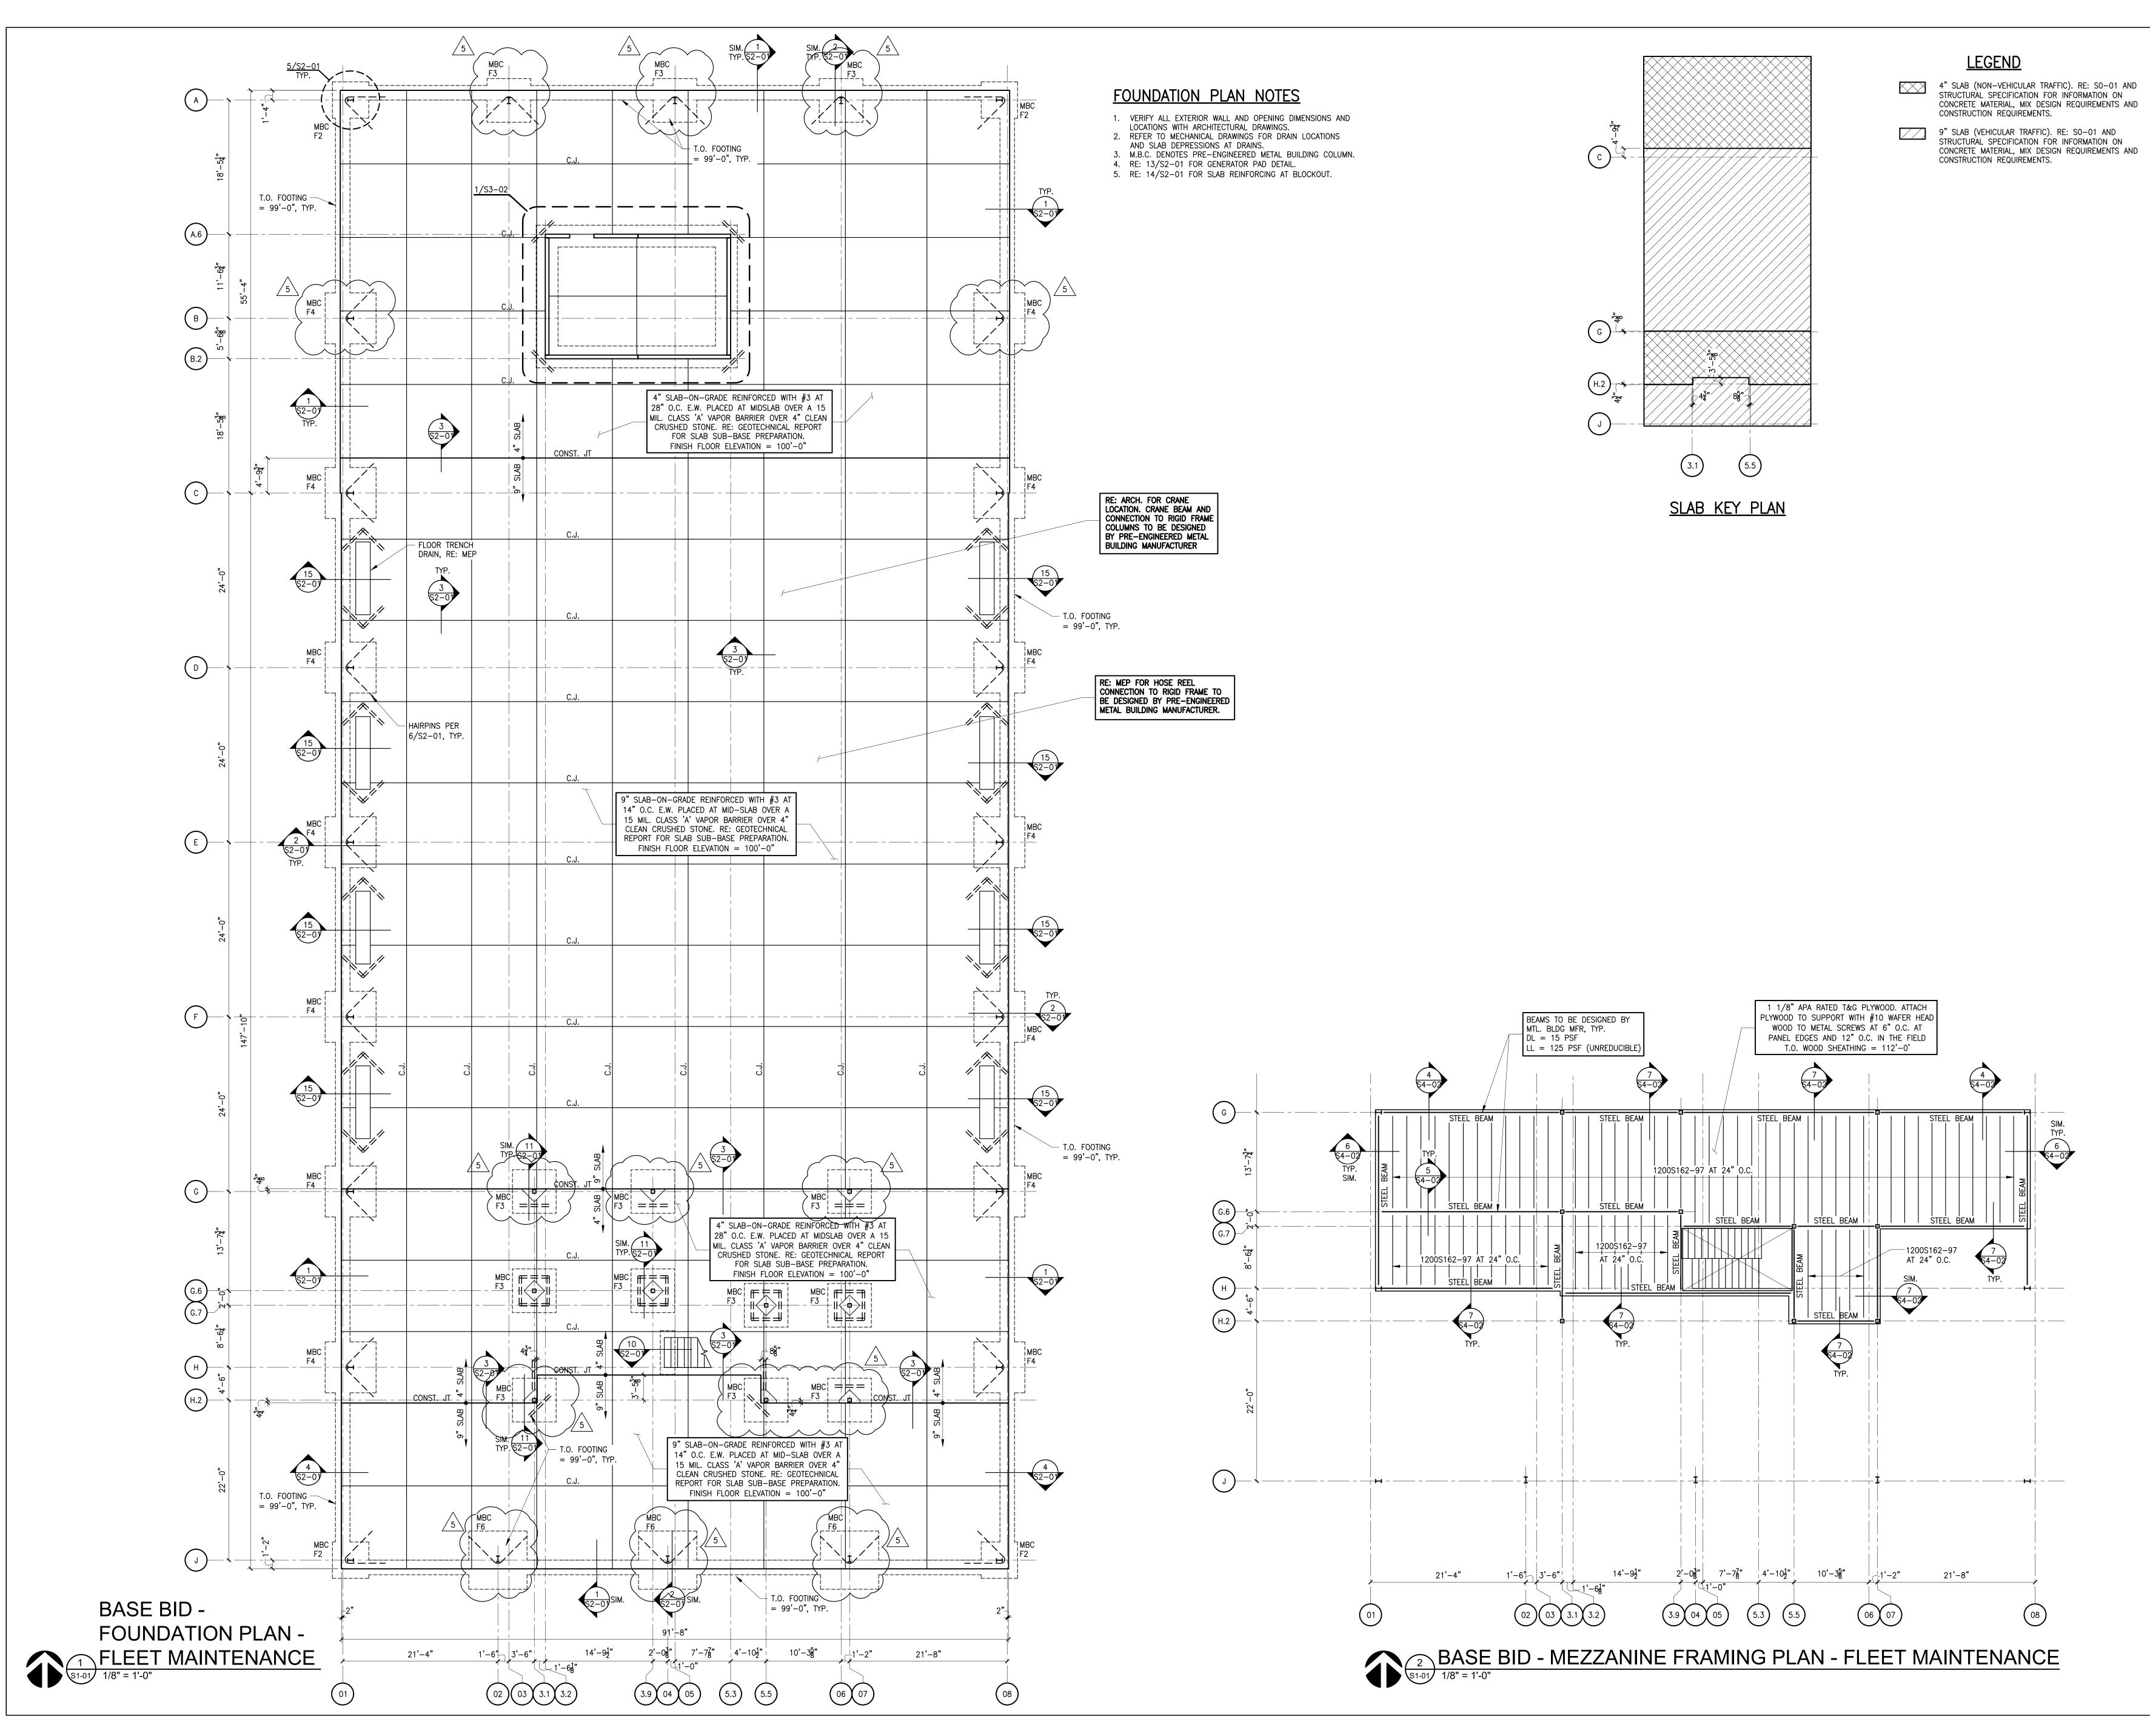



OWNER CITY OF NORMAN, OKLAHOMA 201 A WEST GRAY STREET NORMAN. OKLAHOMA 73069 (405) 366-5406

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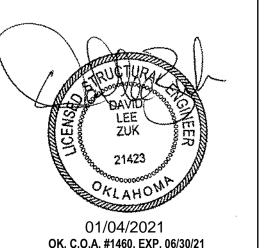
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	01/04/2021 OK. C.O.A. #1460, EXP. 06/30/21								
	REVISIONS								
NO. DATE DESCRIPTION									
<u>\$</u>	01/04/2021	REVISION #5							
CSI	B PROJEC	TNO							
GOI		11 NO. 91650							
	18	71030							
DRAWING TITLE FOUNDATION AND MEZZANINE FRAMING PLAN - FLEET MAINTANANCE									
DV.									

08/28/2020 DRAWING NO.

S1-01

 VERIFY ALL EXTERIOR WALL AND OPENING DIMENSIONS AND LOCATIONS WITH ARCHITECTURAL DRAWINGS.
 M.B.C. DENOTES PRE-ENGINEERED METAL BUILDING COLUMN.



OWNER
CITY OF NORMAN, OKLAHOMA
201 A WEST GRAY STREET
NORMAN, OKLAHOMA 73069
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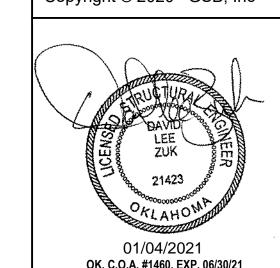
CITY OF NORMAN

ORTH BASE COMPLEX - PHASE 1



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01/04/2021 OK. C.O.A. #1460, EXP. 06/30/21 REVISIONS

NO. DATE DESCRIPTION

O1/04/2021 REVISION #5

GSB PROJECT NO. 191650

DRAWING TITLE

DUMPSTER ENCLOSURE


AND SHED STRUCTURE

FOUNDATION PLANS


DATE 08/28/2020

DRAWING NO.

S1-03

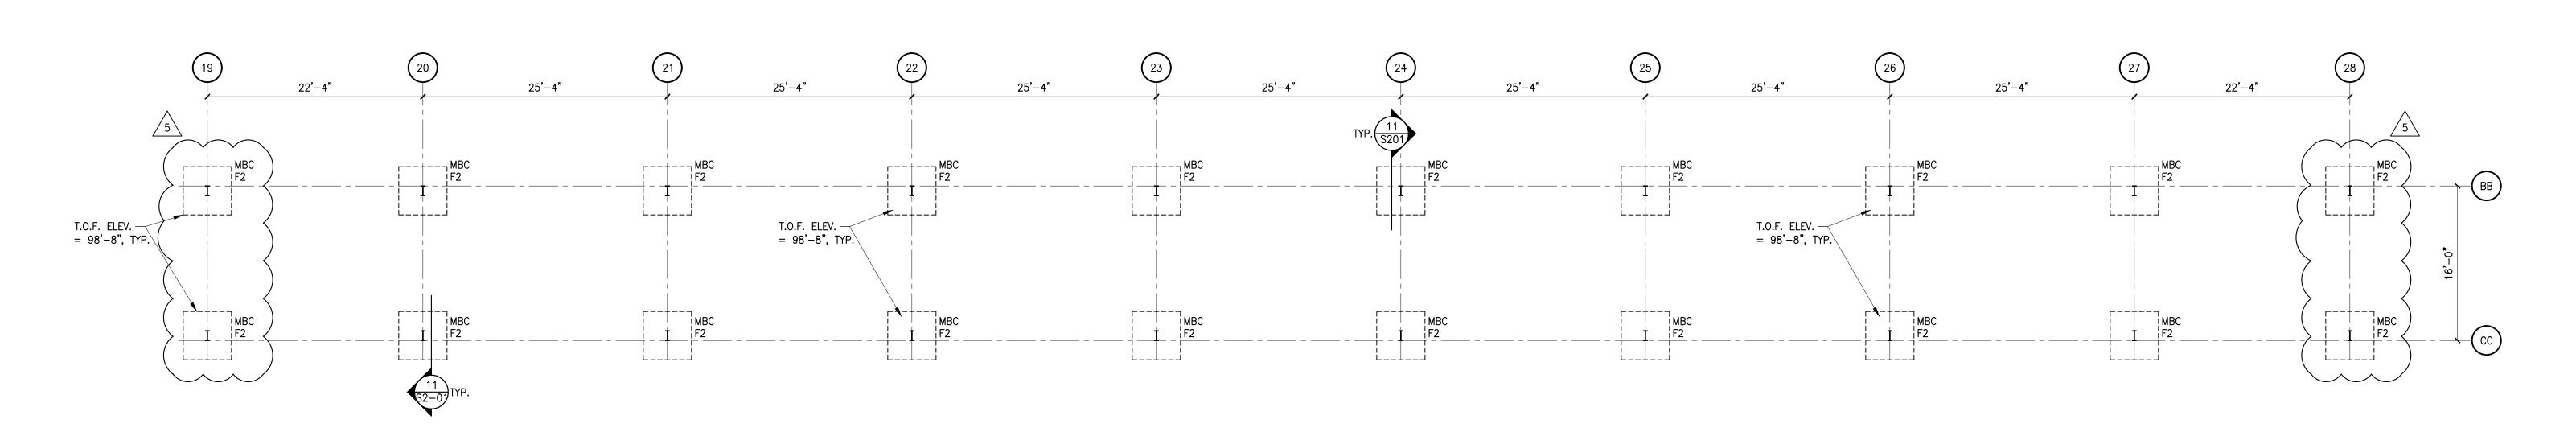




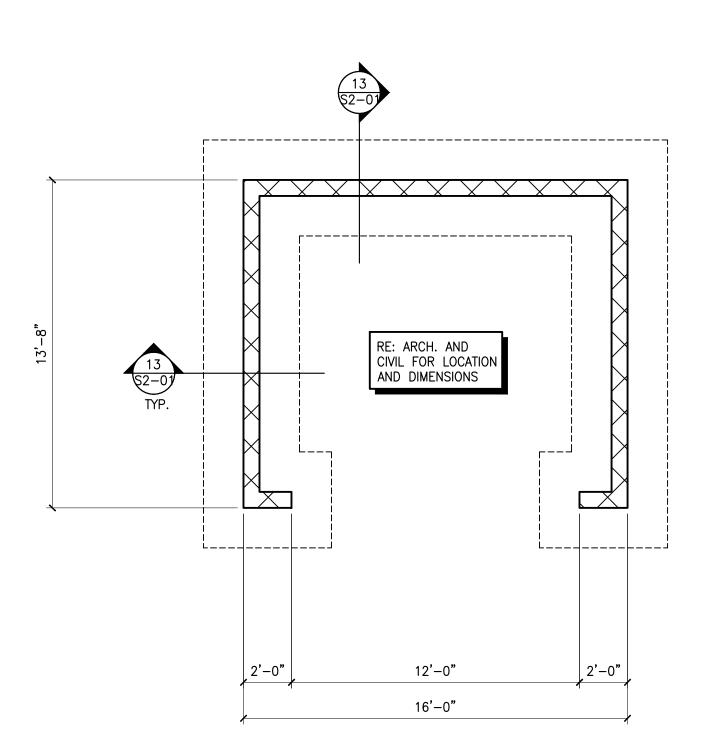


ALTERNATE BID 01 - FOUNDATION PLAN PARKS MAINTENANCE DUMPSTER ENCLOSURE

1/4" = 1'-0"

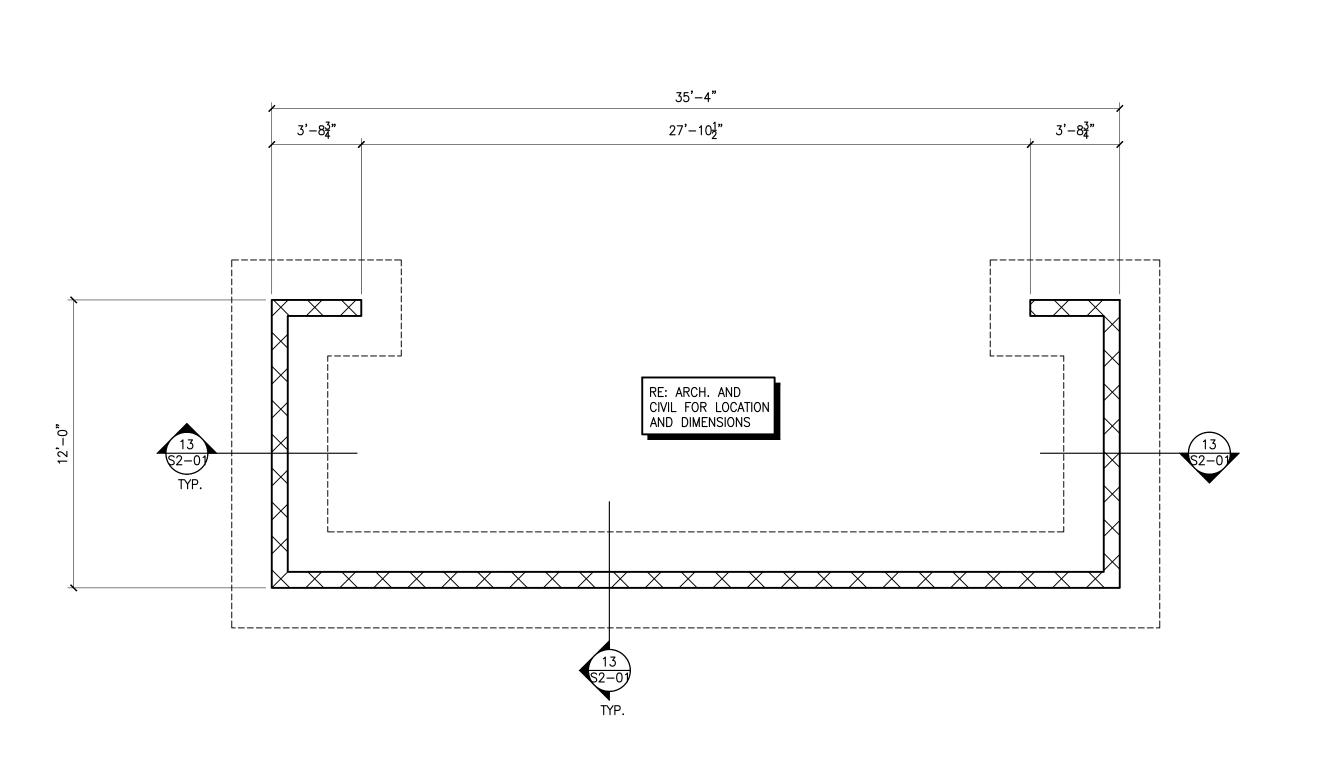

BASE BID - FOUNDATION PLAN 
FLEET MAINTENANCE DUMPSTER ENCLOSURE

1/51-03 1/4" = 1'-0"

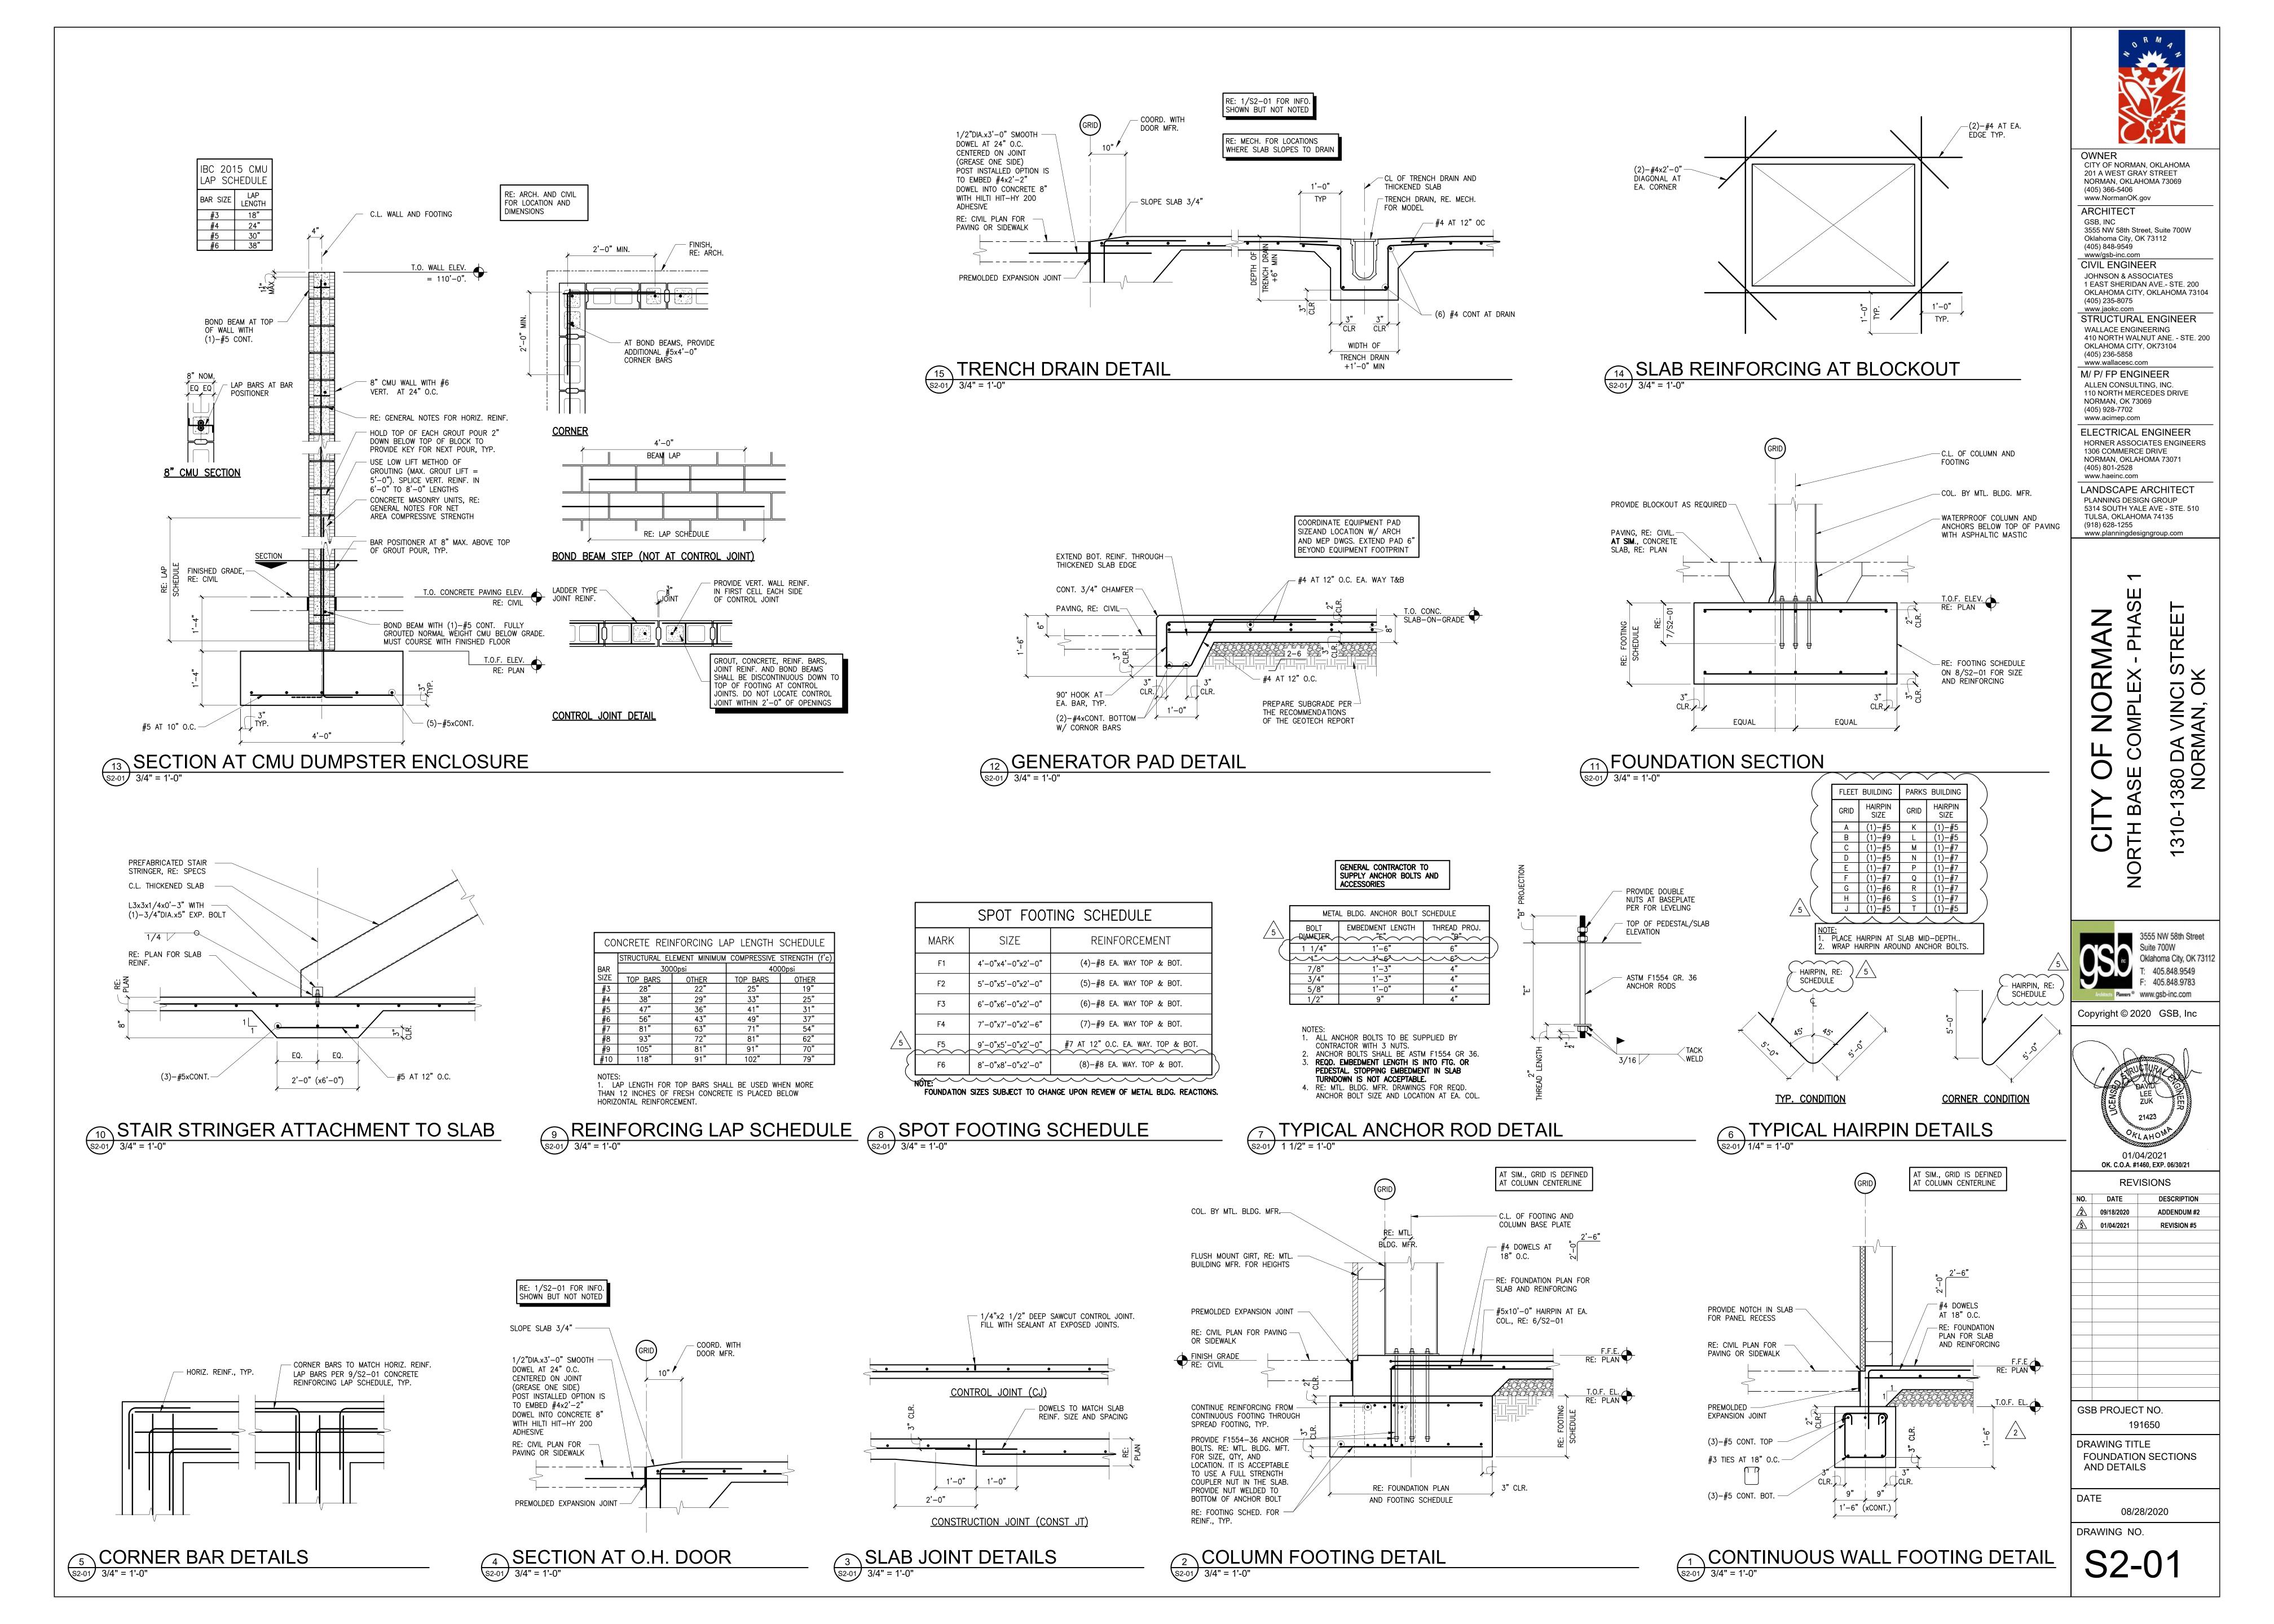

#### PROPOSED CHANGE ORDER SUMMARY

SUBCONTRACTOR WORK or

X CONSTRUCTION MANAGER SELF PERFORMED WORK

Subcontractor Name (if applicable):


Oakridge Builders a Division of Flintco, LLC/4G Concrete, Inc.

#### THE CITY OF NORMAN

Project Name/#: Norman North Base - Phase 1 / 20146 (Alternate)
CE No: #001

CE Title: Revision 5 - Foundation Changes
CE Date: 1/21/2021

PCOR		<u>Labor</u>		<u>Material</u>		<u>Equipment</u>		Subcontract				
Item No Description		Hours		Costs				Type		Cost		Cost
	Direct Labor	2 (@\$45hr)	\$		90.00						\$	90.00
	Direct Materials (Rebar &											
	Concrete)					\$	60.25				\$	60.25
	Direct Subcontracts (Spoils Removal)							Dump Truck	\$	117.00	\$	117.00
-	Supervision/Safety							Dump Truck	Ψ	117.00	\$	-
	Expendable Small Tools							Expendable Tools	\$	10.00	\$	10.00
3	Experidable Small Tools							Experidable roots	Ф	10.00	Ф	10.00
Subtotals			\$		90.00	\$	60.25		\$	127.00	\$	277.25
	urden (@ 58%)		\$		52.20							
	,											
Total Rav	w Costs		\$		329.45							
Overhea	Overhead *		\$		24.71	* Sum of Overhead + Profit limited to ≤ 15% of						
Profit *		\$		24.71			(by contract)					
Subcontr	Subcontractor's Insurance (applies to subcontractor work only)		\$		-	← do not include an amount here if CM Self Performed Work						
	Subcontractor's Bonds (applies to subcontractor work only)		\$		-	← do not include an amount here if CM Self Performed Work						
				If Subcontractor work, enter total in Section 1								
Total for Su	Total for <u>Subcontractor</u> or <u>CM Self-Performed</u> Work		of CM Proposed Change Order Summary form.  \$ 378.87 of CM Proposed Change Order Summary form.  If CM Self-Performed work, enter total in Section 3									
								Change Order Summary Fo				
			l .			L		-				

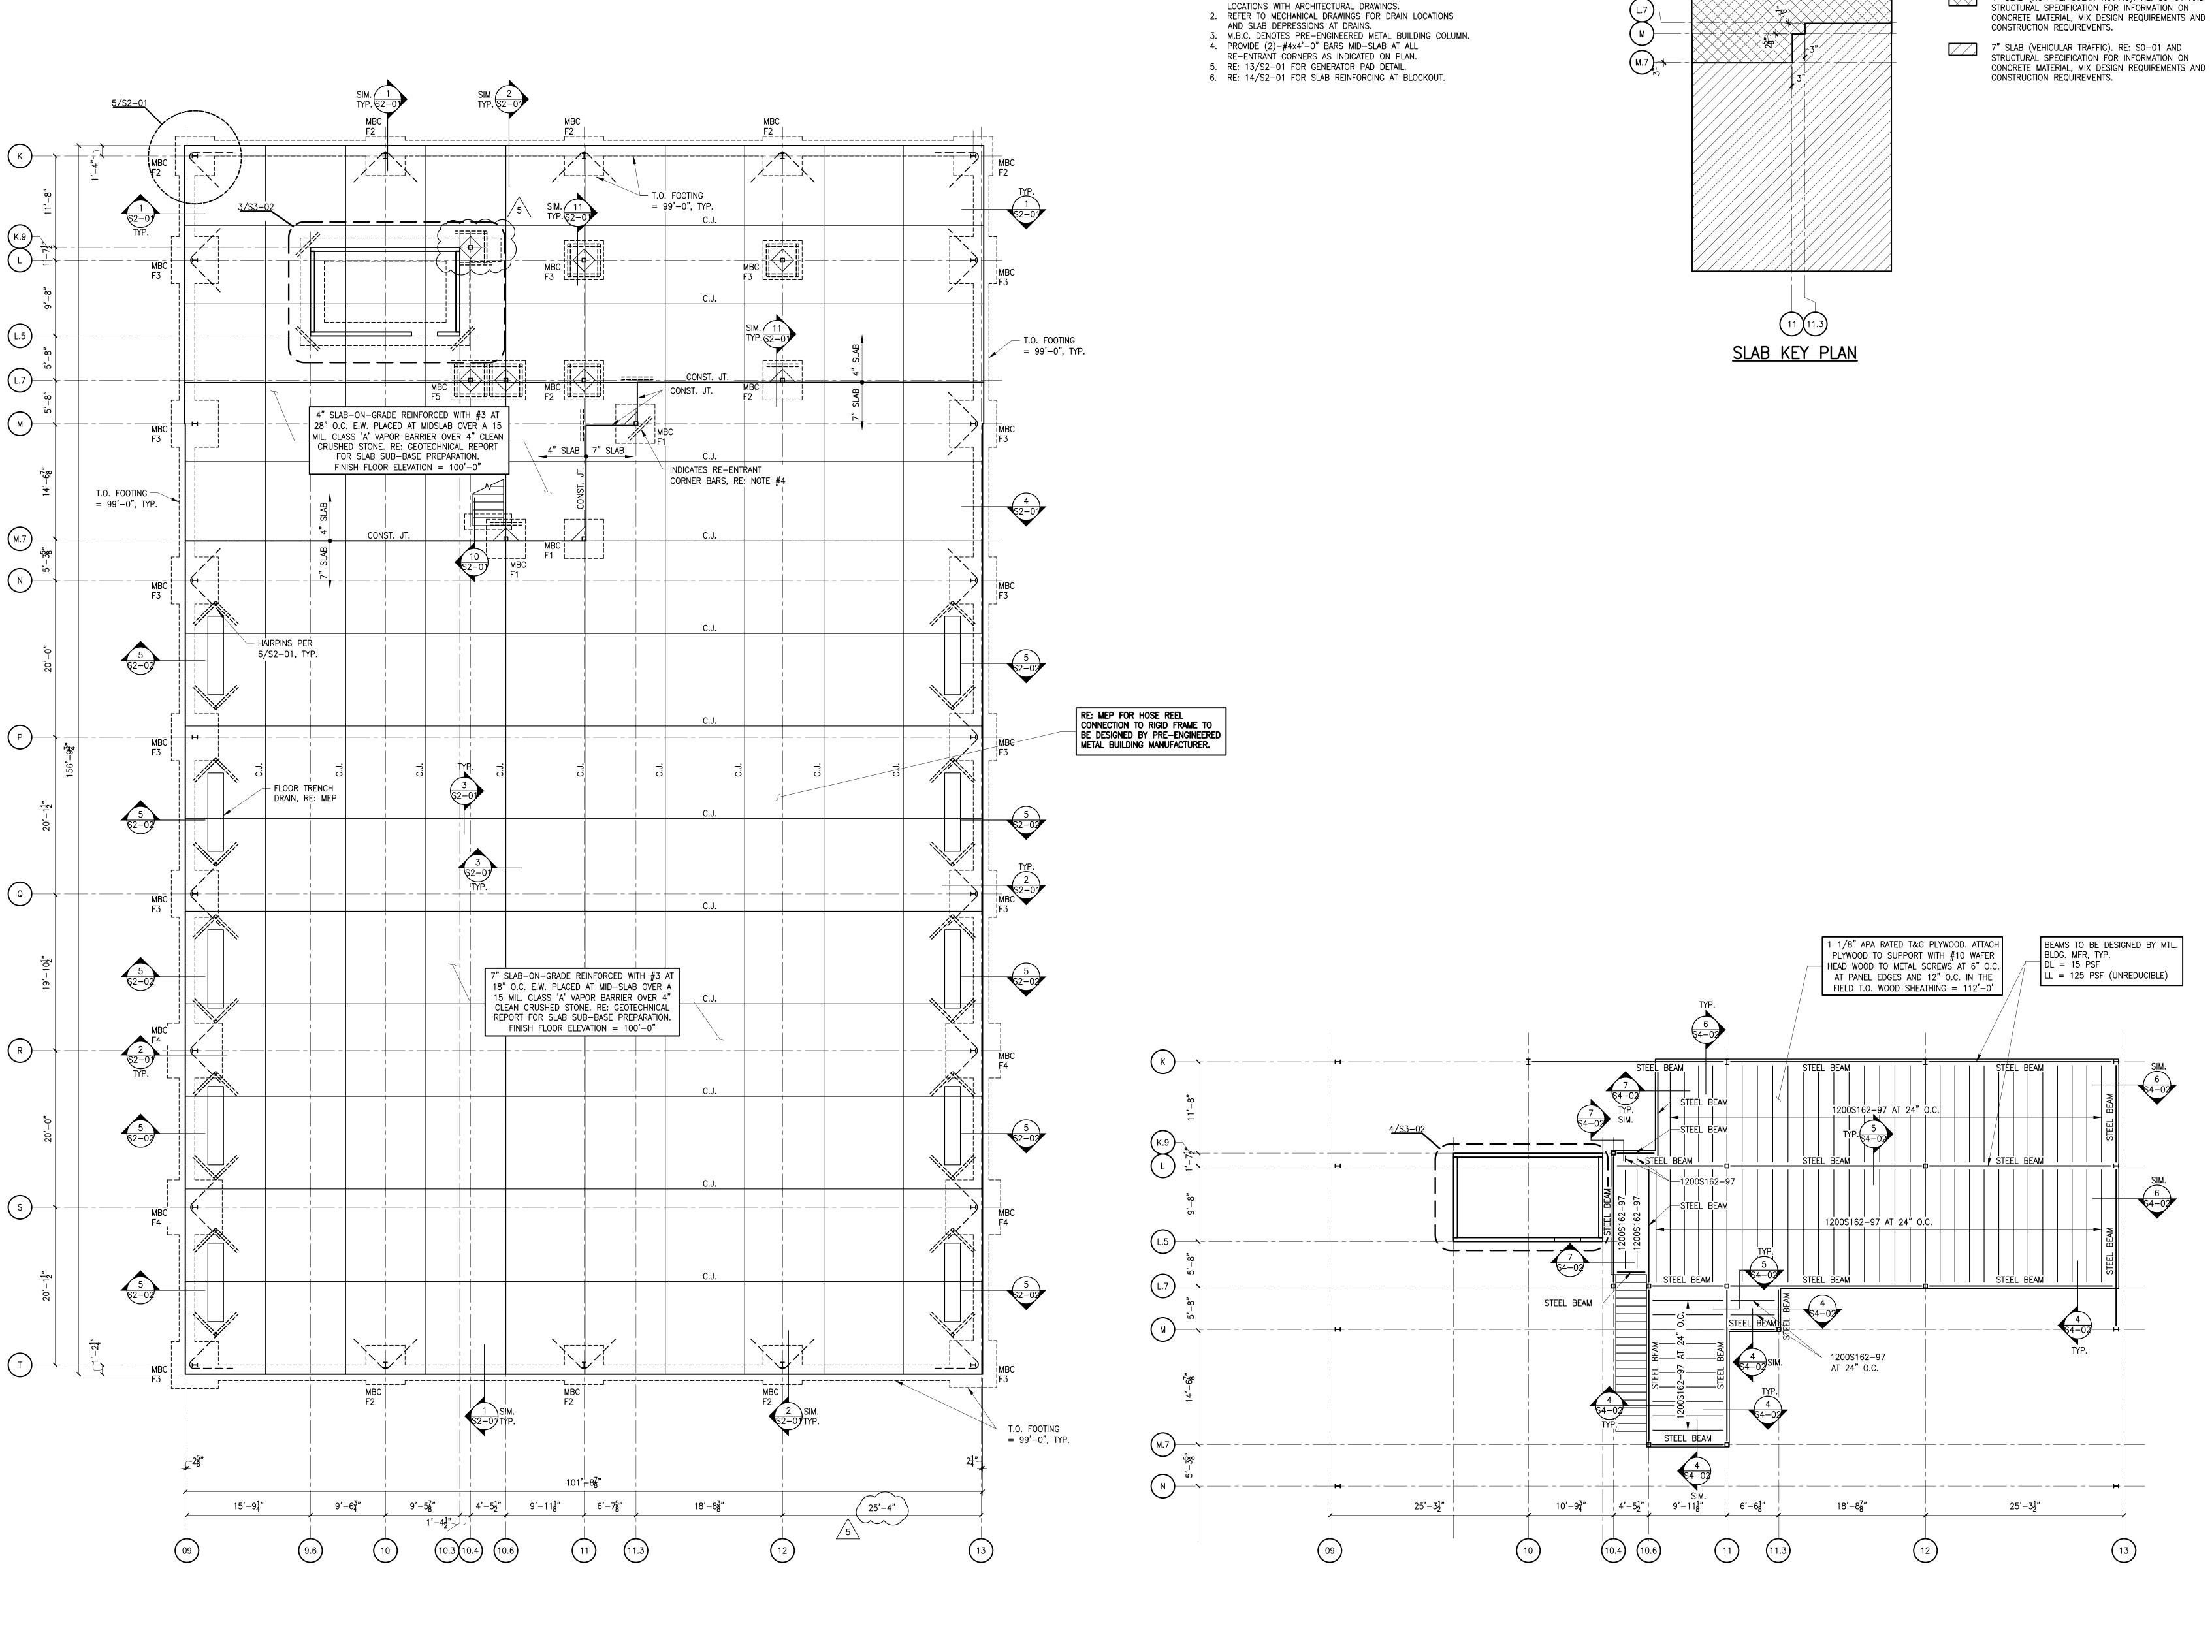

FOUNDATION PLAN NOTES

1. VERIFY ALL EXTERIOR WALL AND OPENING DIMENSIONS AND

<u>LEGEND</u>

- 4" SLAB (NON-VEHICULAR TRAFFIC). RE: SO-01 AND STRUCTURAL SPECIFICATION FOR INFORMATION ON
- 7" SLAB (VEHICULAR TRAFFIC). RE: SO-01 AND STRUCTURAL SPECIFICATION FOR INFORMATION ON CONCRETE MATERIAL, MIX DESIGN REQUIREMENTS AND

OWNER CITY OF NORMAN, OKLAHOMA 201 A WEST GRAY STREET NORMAN, OKLAHOMA 73069 (405) 366-5406 www.NormanOK.gov

ARCHITECT

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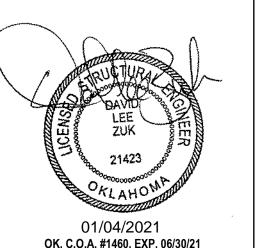
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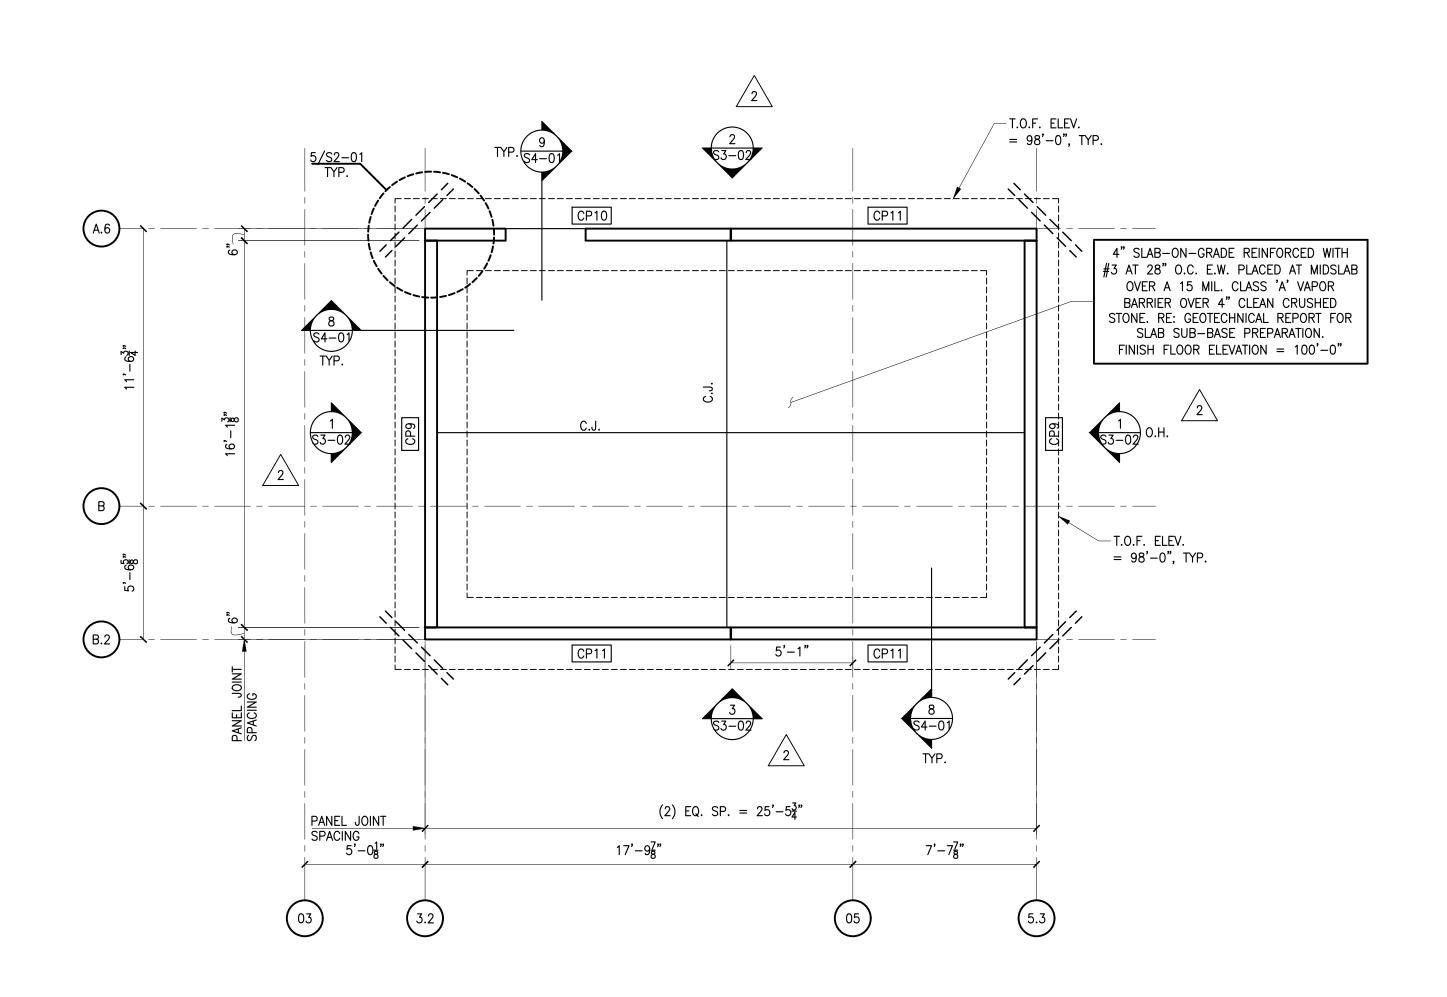
OK. C.O.A. #1460, EXP. 06/30/21

REVISIONS DESCRIPTION 01/04/2021 **REVISION #5** GSB PROJECT NO.


DRAWING TITLE FOUNDATION AND MEZZANINE FRAMING PLAN -PARKS MAINTANANCE

08/28/2020


DRAWING NO. S1-02




CONFERENCE ROOM / TRAINING FOUNDATION PLAN - FLEET

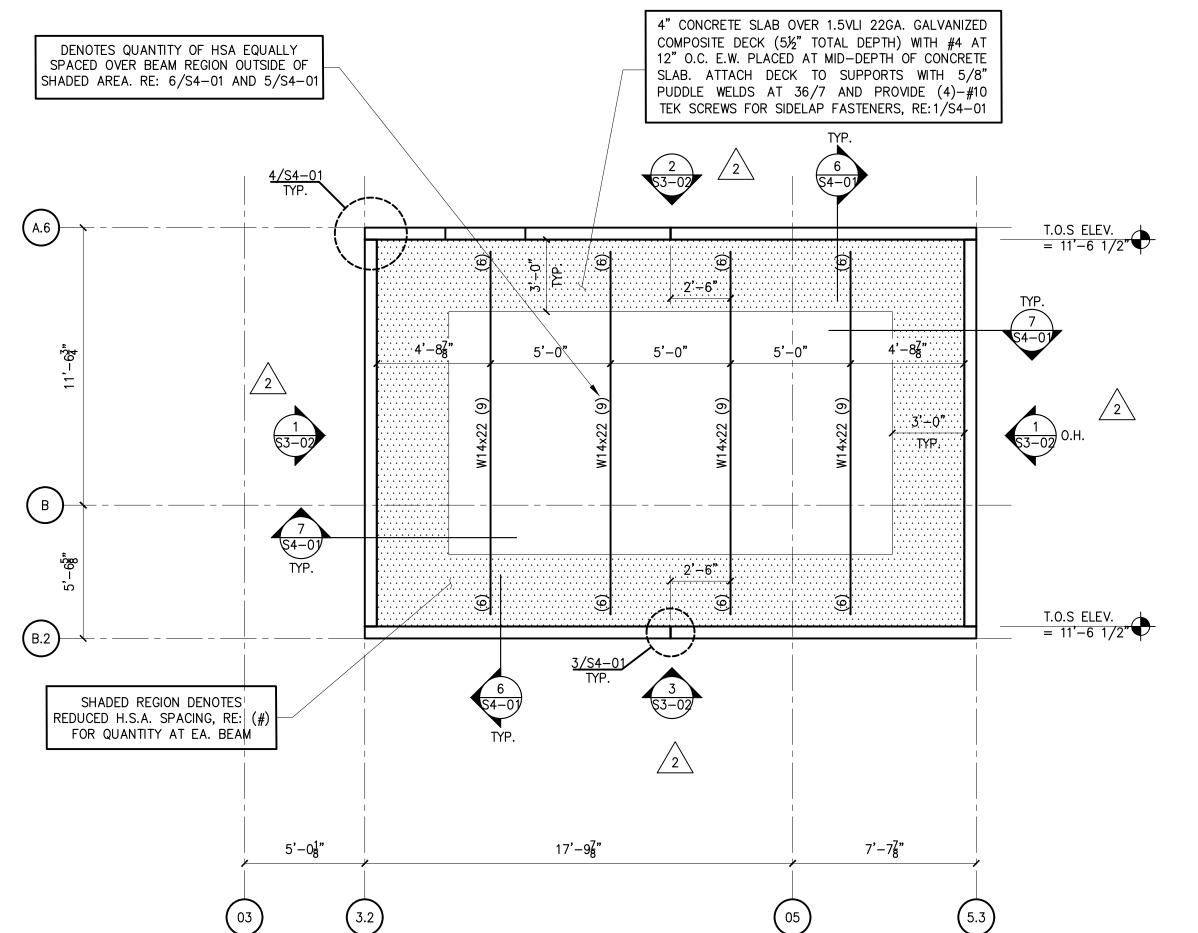

CONFERENCE ROOM / TRAINING FRAMING PLAN - FLEET

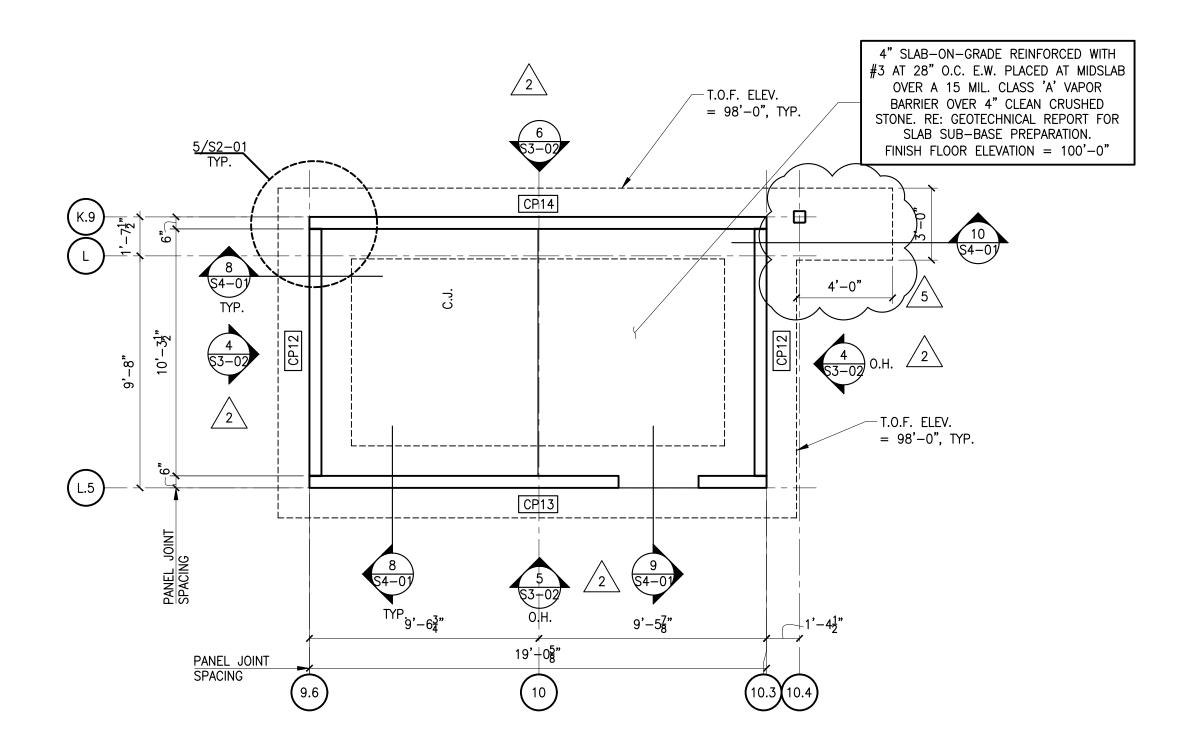

CONFERENCE ROOM / TRANING FOUNDATION PLAN - PARKS 3 MAINTENANCE \$3-01 1/4" = 1'-0"

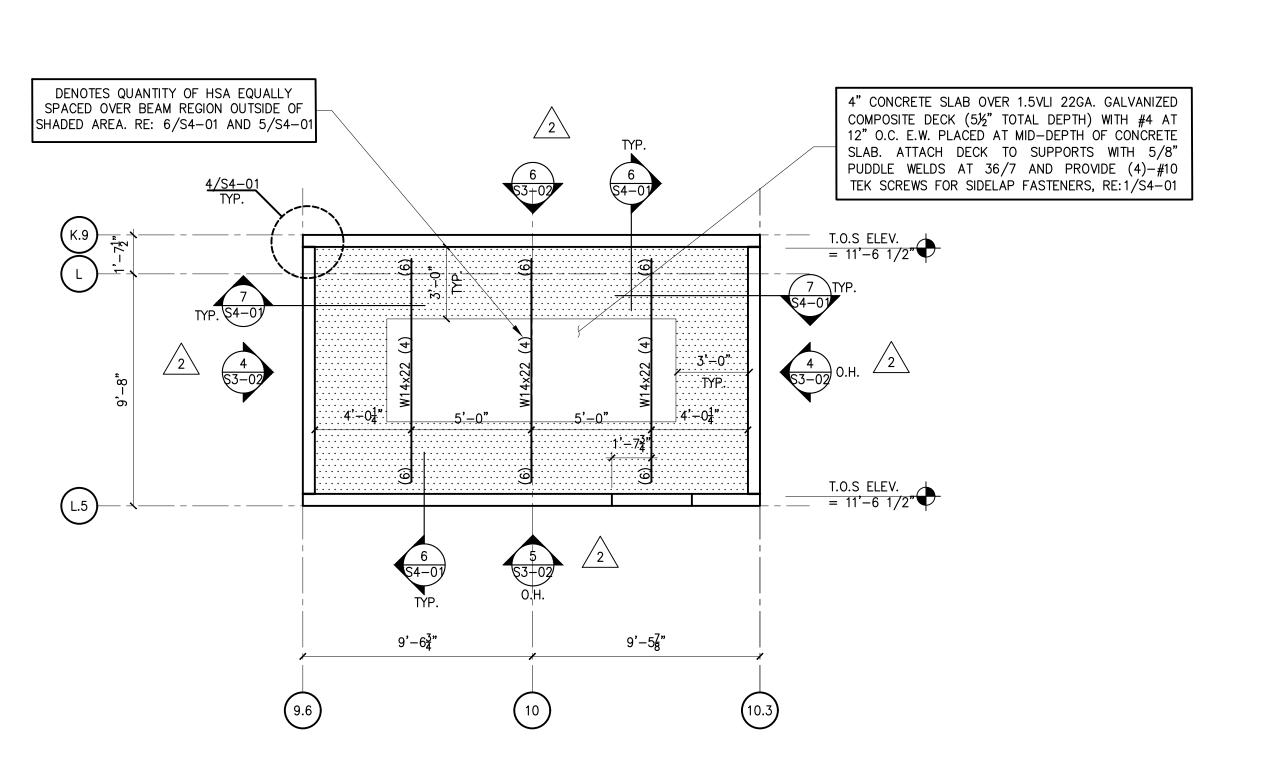

CONFERENCE ROOM / TRAINING FRAMING PLAN - PARKS

4 MAINTENANCE | S3-01 | 1/4" = 1'-0"

# CONFEDENCE DOOM /TDAINING DECICAL DADAMETEDS

<u>CC</u>	NFERENCE ROOM/TRAINING DESIGN PARAMETERS
1.	BUILDING CODE 2015 INTERNATIONAL BUILDING CODE II
	GOVERNING CODE:  ICC/NSSA STANDARD FOR THE DESIGN AND CONSTRUCTION OF STORM SHELTERS  ICC/NSSA 500-2014
2.	GRAVITY LOADS  A. ROOF DEAD LOAD  B. ROOF LIVE LOAD  75 PSF  100 PSF
3.	WIND DESIGN DATA  A. BASIC WIND SPEED (3 SECOND GUST), V 250 MPH  B. WIND EXPOSURE CATEGORY C  C. TOPOGRAPHIC Kzt 1.0  D. DIRECTIONALITY FACTOR, Kd 1.0  E. INTERNAL PRESSURE COEFFICIENT, GCpi ±0.55  F. MFRS WIND PRESSURES ON PRIMARY STRUCTURE  1.) (WINDWARD + LEEWARD) (1.0W) 150 PSF  G. DESIGN WIND PRESSURE ON COMPONENTS AND CLADDING
	ROOF PRESSURES (1.0W)   WALL PRESSURES (1.0W)
4.	<ol> <li>RE: ASCE 7-10 FIGURES 30.4-1 AND 30.4-2A</li> <li>REFER TO CODE FOR EFFECTIVE TRIBUTARY AREAS NOT LISTED</li> <li>PRESSURES NOTED ABOVE ARE TO BE CONSIDERED ACTING         TOWARD AND AWAY FOR THE NOTED SURFACE</li> <li>WIDTH OF END ZONE</li> <li>SEISMIC IMPORTANCE FACTOR, I</li> <li>1.0</li> </ol>
	B. MAPPED SPECTRAL RESPONSE ACCELERATION, Ss 27.2%g C. MAPPED SPECTRAL RESPONSE ACCELERATION, S1 7.9%g D. SITE CLASS D E. SPECTRAL RESPONSE COEFFICIENT, Sds 0.287 F. SPECTRAL RESPONSE COEFFICIENT, Sd1 0.126 G. SEISMIC DESIGN CATEGORY B H. STRUCTURAL SYSTEM ——
	1.) BASIC SEISMIC FORCE—RESISTING SYSTEM 2.) VERTICAL ELEMENT TYPE 3.) DESIGN BASE SHEAR, (1.0E)  BEARING WALL SYSTEMS ORDINARY REINFORCED CONCRETE SHEAR WALLS 0.072W

J. ANALYSIS PROCEDURE

- PRIOR TO CONSTRUCTION A PRE-CONSTRUCTUION MEETING SHALL BE HELD WITH THE ARCHITECT AND AWARDED TESTING AGENCY. THE AGENDA IS TO INCLUDE A DISCUSSION OF CONFERENCE
- IN ACCORDANCE WITH SECTION 107.3.3 OF THE ICC 500-2014, CONTRACTORS RESPONSIBLE FOR THE CONSTRUCTION OF THE CONFERENCE ROOM/TRAINING SHALL SUBMIT A WRITTEN STATEMENT OF RESPONSIBILITY TO THE AUTHORITY HAVING JURISDICTION, ENGINEER OF RECORD, AND OWNER PRIOR
- DURING CONSTRUCTION OF THE CONFERENCE ROOM/TRAINING, THE OWNER SHALL EMPLOY A PROFESSIONAL ENGINEER REGISTERED IN THE STATE OF OKLAHOMA TO CONDUCT VISUAL OBSERVATIONS OF THE CONSTRUCTION OF STRUCTURAL SYSTEMS FOR CONFORMANCE TO THE APPROVED CONSTRUCTION DOCUMENTS AT SIGNIFICANT CONSTRUCTION STAGES AND AT THE COMPLETION OF THE CONSTRUCTION OF STRUCTURAL SYSTEMS. THE REGISTERED DESIGN ENGINEER WHO MADE THE STRUCTURAL OBSERVATIONS SHALL SUBMIT A WRITTEN LETTER STATING THE SITE VISITS HAVE BEEN MADE AND REPORTING ALL OUTSTANDING DEFICIENCIES PER ICC/NSS 500-2014 SECTION 106.4. SIGNIFICANT

B. INSTALLATION OF WALL PANEL REINFORCING PRIOR TO ANY CONCRETE POURING OF THE TILT-UP WALL

AND PROPER BAR LOCATIONS INCLUDING JAMB REINFORCING. STRUCTURAL OBSERVATIONS ARE IN ADDITIONAL TO SPECIAL INSPECTIONS CONDUCTED BY THE AWARDED

- FOR SPECIAL INSPECTIONS AS SUMMARIZED IN THE GENERAL NOTES AND REQUIRED BY IBC 2015. 4. ALL OPENINGS IN ROOF AND WALLS ARE PROTECTED BY STEEL SHROUDS OR CONRETE BARRIERS THAT
- DOORS SHALL MEET THE REQUIRED DEBRIS IMPACT TEST MISSILE CRITERIA FOR A 15 POUND SAWN LUMBER 2x4 TRAVELING AT A SPEED OF 100 MPH FOR VERTICAL SURFACES USING THE REQUIRED TEST METHODS OF CHAPTER 8 OF ICC 500-2014.
- CONTRACTOR RESPONSIBILITY: GENERAL CONTRACTOR, AND RELATED SUBCONTRACTORS RESPONSIBLE FOR CONSTRUCTION OF THE MAIN WIND FORCE RESISTING SYTEM, EXTERIOR COMPONENTS, AND CRITICAL SUPPORT SYSTEMS FOR THE STRUCTURE SHALL SUBMIT A WRITTEN STATEMENT OF RESPONSIBILITY PRIOR TO COMMENCEMENT OF WORK ON THE SYSTEM OR COMPONENT AS REQUIRED IN SECTION 107.3.3 OF THE ICC 500-2014. THE CONTRACTOR'S STATEMENT OF RESPONSIBILITY SHALL

  - CONSTRUCTION DOCUMENTS. C. PROCEDURES FOR EXERCISING CONTROL WITHIN THE CONTRACTOR'S ORGANIZATION, THE METHOD
- AND FREQUENCY OF REPORTING AND THE DISTRIBUTION OF REPORTS. D. IDENTIFICATION AND QUALIFICATIONS OF THE PERSON(S) EXERCISING SUCH CONTROL AND THEIR
- E. THIS REQUIREMENT CAN BE MET FOR PREFABRICATED OR PANELIZED CONFERENCE ROOM/TRAINING COMPONENTS WHICH HAVE BEEN INSPECTED AND LABELED BY AN APPROVED

AGENCY MEETING THE REQUIREMENTS OF THE BUILDING CODE AND ICC 500-2014.



CITY OF NORMAN, OKLAHOMA 201 A WEST GRAY STREET NORMAN, OKLAHOMA 73069 (405) 366-5406 www.NormanOK.gov

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JOHNSON & ASSOCIATES 1 EAST SHERIDAN AVE.- STE. 200 OKLAHOMA CITY, OKLAHOMA 73104 (405) 235-8075 www.jaokc.com STRUCTURAL ENGINEER

CIVIL ENGINEER

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CONFERENCE ROOM/TRAINING STRUCTURAL GENERAL NOTES:

4.) RESPONSE MODIFICATION FACTOR

ENGINEER OF RECORD, GENERAL CONTRACTOR, THE FOREMEN FROM EACH RELATED SUB-CONTRACTOR, ROOM/TRAINING CONSTRUCTION QUALITY ASSURANCE PLAN IN ACCORDANCE WITH THE ICC 500-2014 SECTION 107.3.1 AND 107.3.2.

EQUIVALENT LATERAL FORCE

TO THE COMMENCEMENT OF WORK.

STAGES OF CONSTRUCTION ARE AS FOLLOWS:

A. INSTALLATION OF FOUNDATION REINFORCING PRIOR TO POURING OF CONCRETE. PANELS. OBSERVATION IS REQUIRED AT EACH WALL PANEL PRIOR TO ANY CONCRETE POUR. C. INSTALLATION OF DECK SLAB REINFORCING PRIOR TO POURING CONCRETE. REINFORCING OBSERVATIONS ARE TO REVIEW ITEMS LISTED HEREIN BUT ARE NOT LIMITED TO: REINFORCMENT SIZES AND QUANTITIES, REINFORCING LAP LENGTHS AND LOCATIONS, BAR POSITIONERS

TESTING AGENCY. STRUCTURAL OBSERVATIONS DO NOT SERVE AS OR ELIMINATE THE REQUIREMENT

MEET THE WIND PRESSURE AND PROJECTILE REQUIREMENTS OF THE ICC 500-2014.

QUALITY ASSURANCE PLAN: REFER TO SHEET SO-01 & SO-02 FOR SPECIAL INSPECTIONS, STRUCTURAL OBSERVATIONS AND REQUIREMENTS.

A. ACKNOWLEDGEMENT OF AWARENESS OF THE SPECIAL REQUIREMENTS CONTAINED IN THE QUALITY

B. ACKNOWLEDGEMENT THAT CONTROL WILL BE EXERCISED TO OBTAIN COMPLIANCE WITH

POSITION(S) IN THE ORGANIZATIONS.

SPECIAL INSPECTION SHALL BE CONDUCTED ON ALL POST-INSTALLED ANCHORS IN CONFERENCE

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3

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OK. C.O.A. #1460, EXP. 06/30/21 REVISIONS

DESCRIPTION 2 09/18/2020 ADDENDUM #2 <u>/5</u> 01/04/2021 **REVISION #5** 


**GSB PROJECT NO.** 

DRAWING THE CONFERENCE ROOM FOUNDATION AND FRAMING PLANS

08/28/2020

DRAWING NO.

S3-01

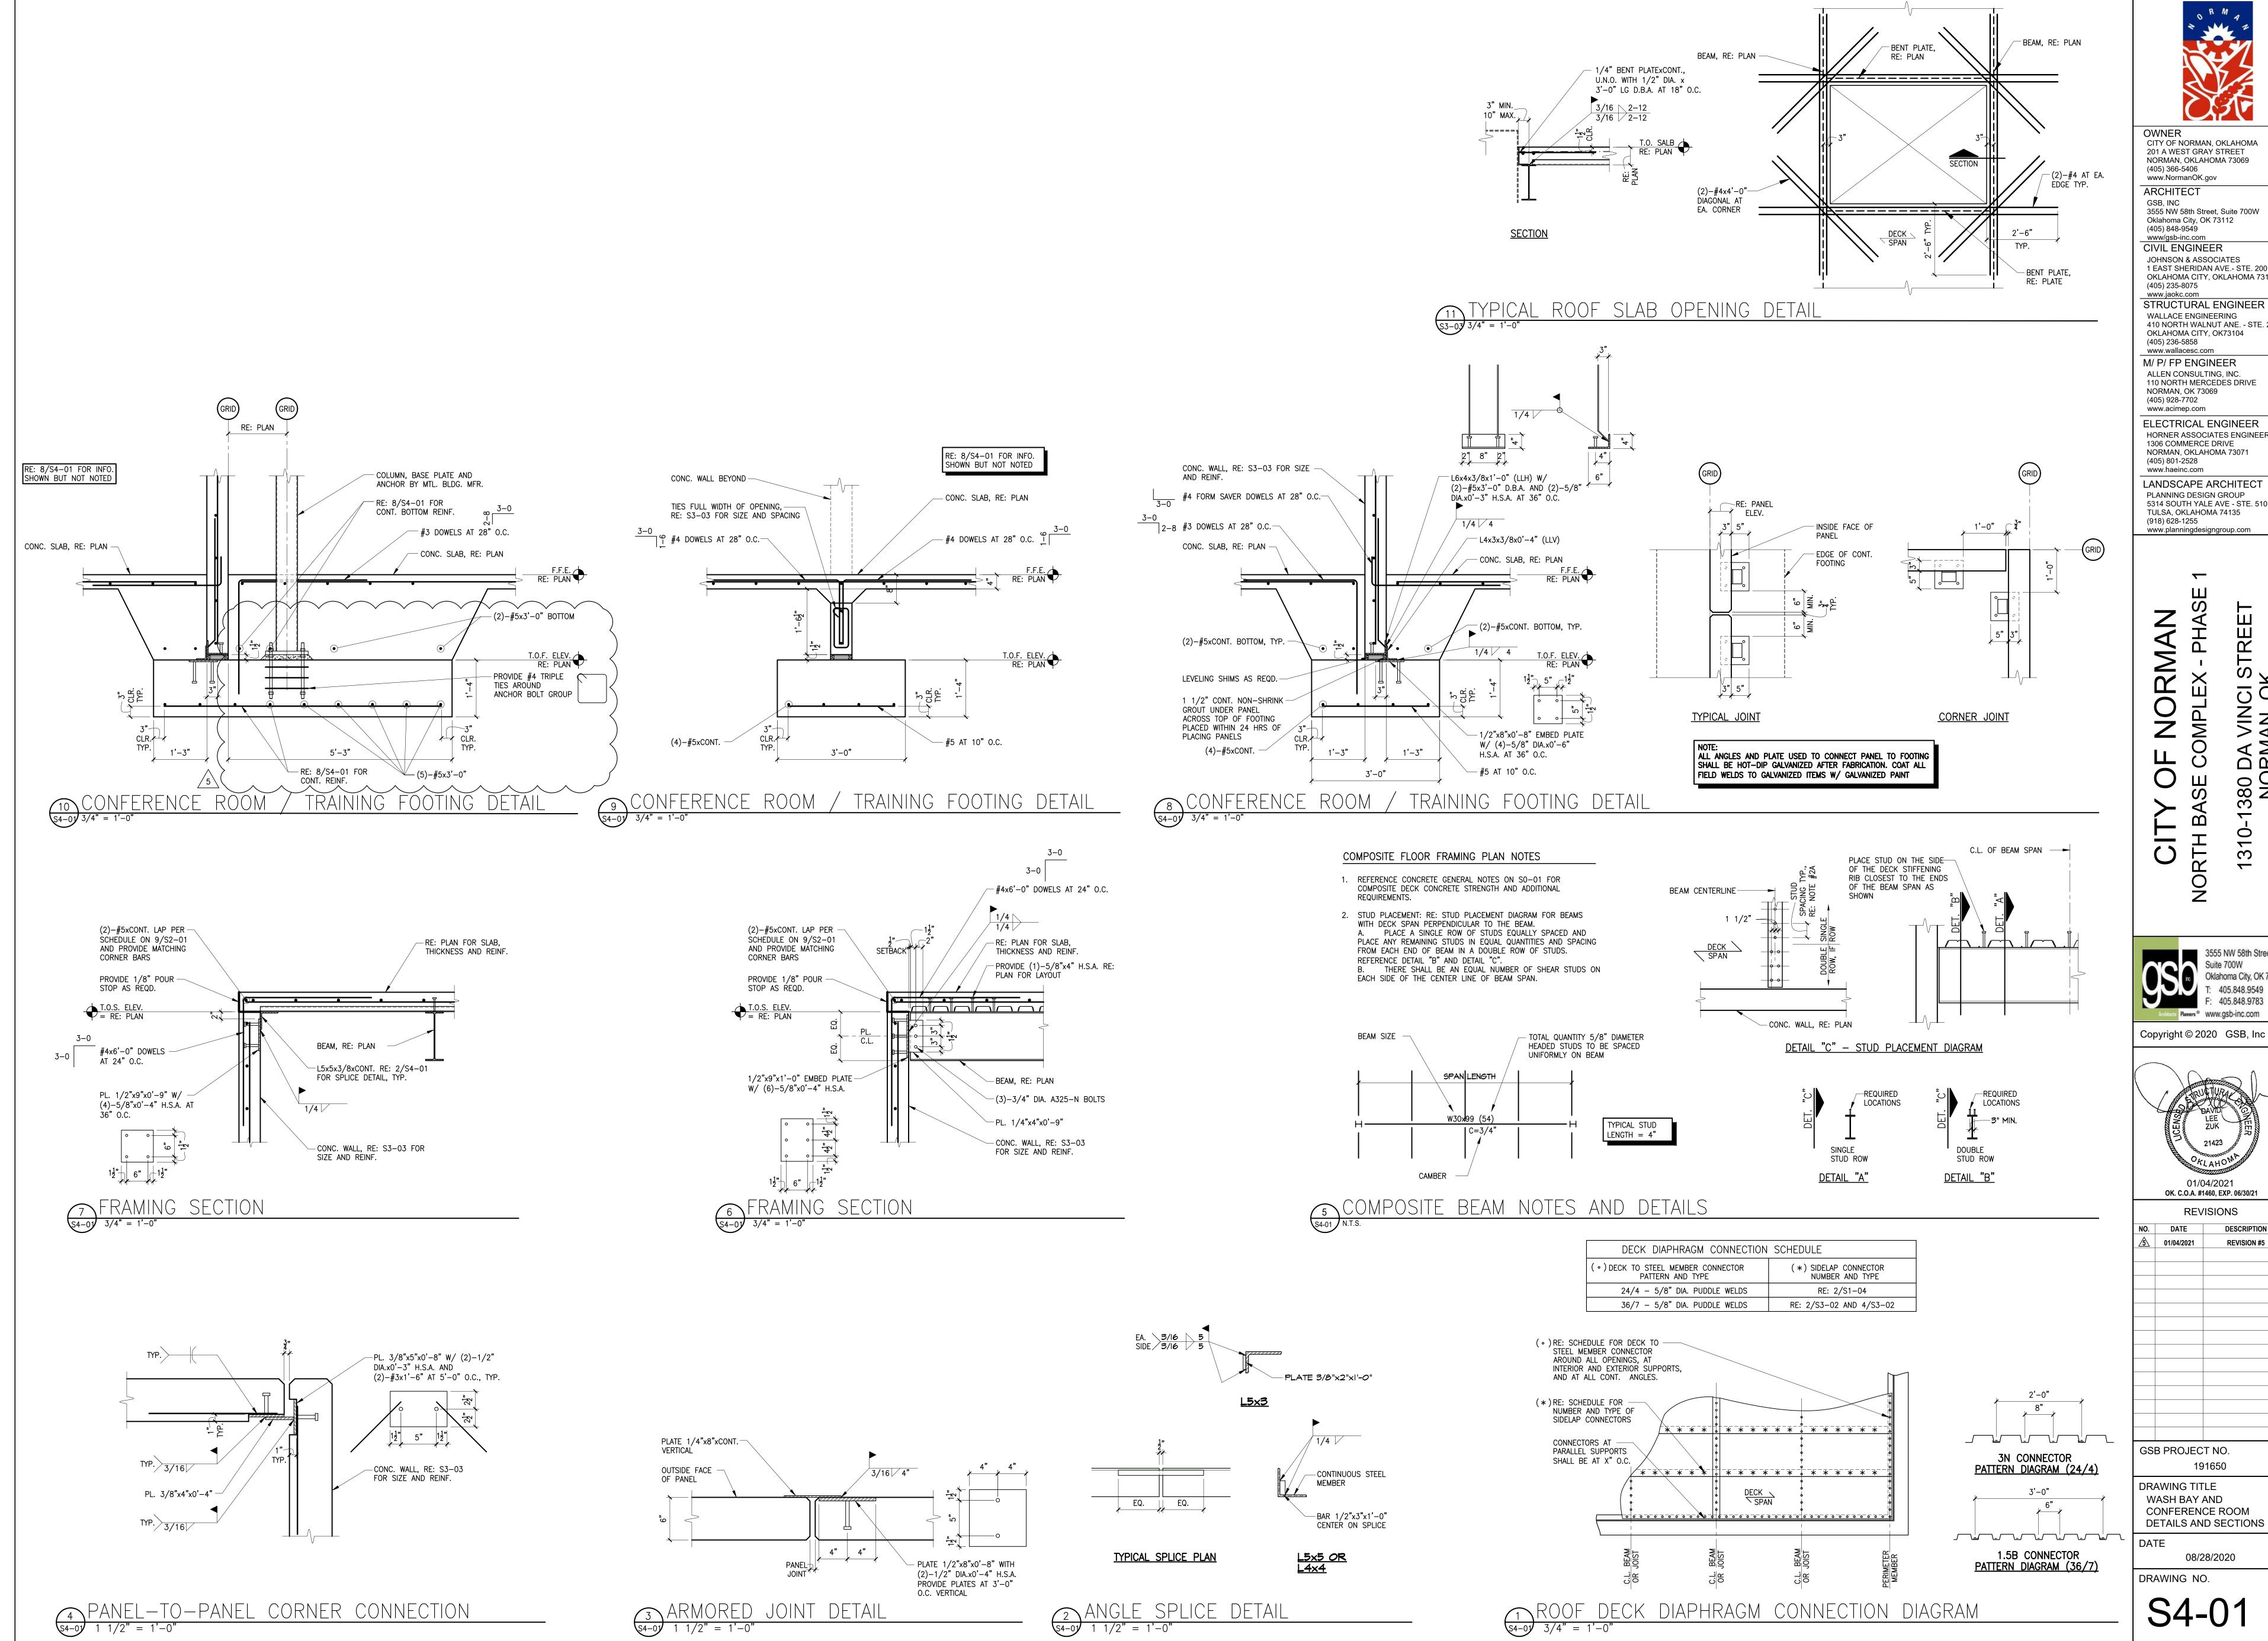

OWNER CITY OF NORMAN, OKLAHOMA 201 A WEST GRAY STREET NORMAN, OKLAHOMA 73069 (405) 366-5406

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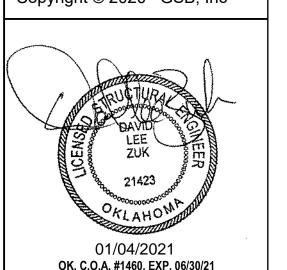
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	OK. C.O.A. #	1460, EXP. 06/30/21
	RE\	/ISIONS
NO.	DATE	DESCRIPTION
<u>/5\</u>	01/04/2021	REVISION #5
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GS	B PROJEC	CT NO.
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CONFERENCE ROOM

08/28/2020

S4-01

# **REVISION 6**

Lic. No. OK 02653 **H & H Plumbing & Utilities, Inc.** 381 W. Adkins Hill Road, Norman, OK 73072-9218 (405) 288-2346 (405) 288-2349 FAX

Sheet (1) of (1)

Contractor: Address:	Flintco, LLC 2302 S. Prospect		Ph.#: 670-6307 Fax #: 670-6568		Address: 1310	th Base Complex 0 - 1380 Da Vinc	i St.
	Oklahoma City, OK		Email: okcestimating			man, OK 73071	
	erials, taxes, permits, soutlined below.	staking, and mainte	enance bonds for a d	complete Site	Utility install	ation as describe	ed on the
	vering for Storm						
ITEM #	ITEM			UNIT	Qty	PRICE	TOTAL
1	8" C-900 DR14 PVC	• •		LF	40	30.00	1,200.00
2 3	8" x 45° Bend (Vertic	,		EA	8	875.00	7,000.00
3	Sand bedding & back	.1111		CY	10	20.00	200.00
	A.6. I						8,400.00
	After hours work						1,500.00
	Maintenance bonds (	Water & Sanitary)					125.00
							10,025.00
Spoils Rei	moval from Site			CY			-
Spoils rem Payment &	ater meter impact fees oval from site (If requir performance bonds (I location of any existing	ed <b>Add \$00.00</b> to the following to the following the foll	s 1.44%.)		Contract A	mount &	10.025.00
					Contract A	mount \$	10,025.00
Submitted	By: Jason Lawrance	)	Title:	Project Ma	ınager	Date:	1/27/2021
Accepted E	Ву:		Title:			Date:	



Flintco LLC (40-000) 2302 South Prospect Oklahoma City , Oklahoma 73129 Phone: (405) 670-6307 Project: 20136 - City of Norman - North Base Complex Phase 1 1310-1380 DA Vinci Street Norman, Oklahoma 73069

Storm Sewer Constraints					
TO:	Michael Segroves GSB, Inc. 3555 NW 58th Street, Suite 700W Oklahoma City, Oklahoma 73112	FROM:	Zack Blair Flintco, LLC - OKC 2302 S. Prospect Oklahoma City, Oklahoma 73129		
DATE INITIATED:	01/15/2021	STATUS:	Open		
REFERENCE:		DUE DATE:	01/26/2021		
COST IMPACT:	Yes (Unknown)	SCHEDULE IMPACT:	Yes (Unknown)		
DRAWING NUMBER:	ST5				
LINKED DRAWINGS:		RECEIVED FROM:	Jason Lawrance (H & H Plumbing & Utilities, Inc.)		

#### **COPIES TO:**

Carolyn Bennett (GSB, Inc.), Paul D'Andrea (City of Norman), Geoff Evans (Planning Design Group), Phillip Gunderson (Flintco, LLC - OKC), Sarah Hendrickson (ADG), Randy Hill (ADG), Cory Rackley (Flintco, LLC - OKC), David Stanton (GSB, Inc.), David Stapp (Flintco, LLC - OKC), Ethan Treisa (Flintco, LLC - OKC)

#### Question from Zack Blair (Flintco, LLC - OKC) at 04:22 PM on 01/15/2021

Reference Civil sheets ST5, ST6, and attached sketch SK1

As detailed in the attached sketch, the existing 8" city water main is conflicting with storm lines "B" and "C".

For storm sewer line B, the conflict occurs between structures B02 and B03, and also conflicts between structures B03 and B04, since the water main is running at a diagonal. At each conflict, top of storm pipe is approximately 1176.95' and the top of the 8" water main is at 1176.82' If this storm pipe was to raise to avoid the water main, then the existing storm line would not be able to be picked up due to its existing elevation.

For storm sewer line C, The conflict occurs between structures C01 and A02. At this conflict, the top of storm sewer pipe is at elevation 1177.36', and the top of the 8" water main is at 1176.82'. If the storm pipe changed elevations, it would then be conflicting with a phone line.

Proposed solution for all conflicts: Lower the city water main to avoid storm sewer. Please confirm this solution is acceptable and advise if this work will be completed by the City of Norman or if it should be an add to the contract. If added to Flintco's scope, please advise desired elevation for water main.

#### Attachments:

RFI 019 - SK1.pdf

#### Official Response

Awaiting an Official Response

#### All Replies:


Johnson & Associates has reviewed the documents supplied with the RFI.

Johnson & Associates agrees with the proposed solution to lower the water lines at the conflicting locations.

A minimum clearance of 2 feet shall be maintain at these locations between storm sewer and water lines.

Discussion needs to occur between the City of Norman and the Design Team's point of contact to discuss how this will be paid for.

As noted in the RFI, will the work be by change order under the existing contract with contractor and the City of Norman or will the City of Norman perform this work.

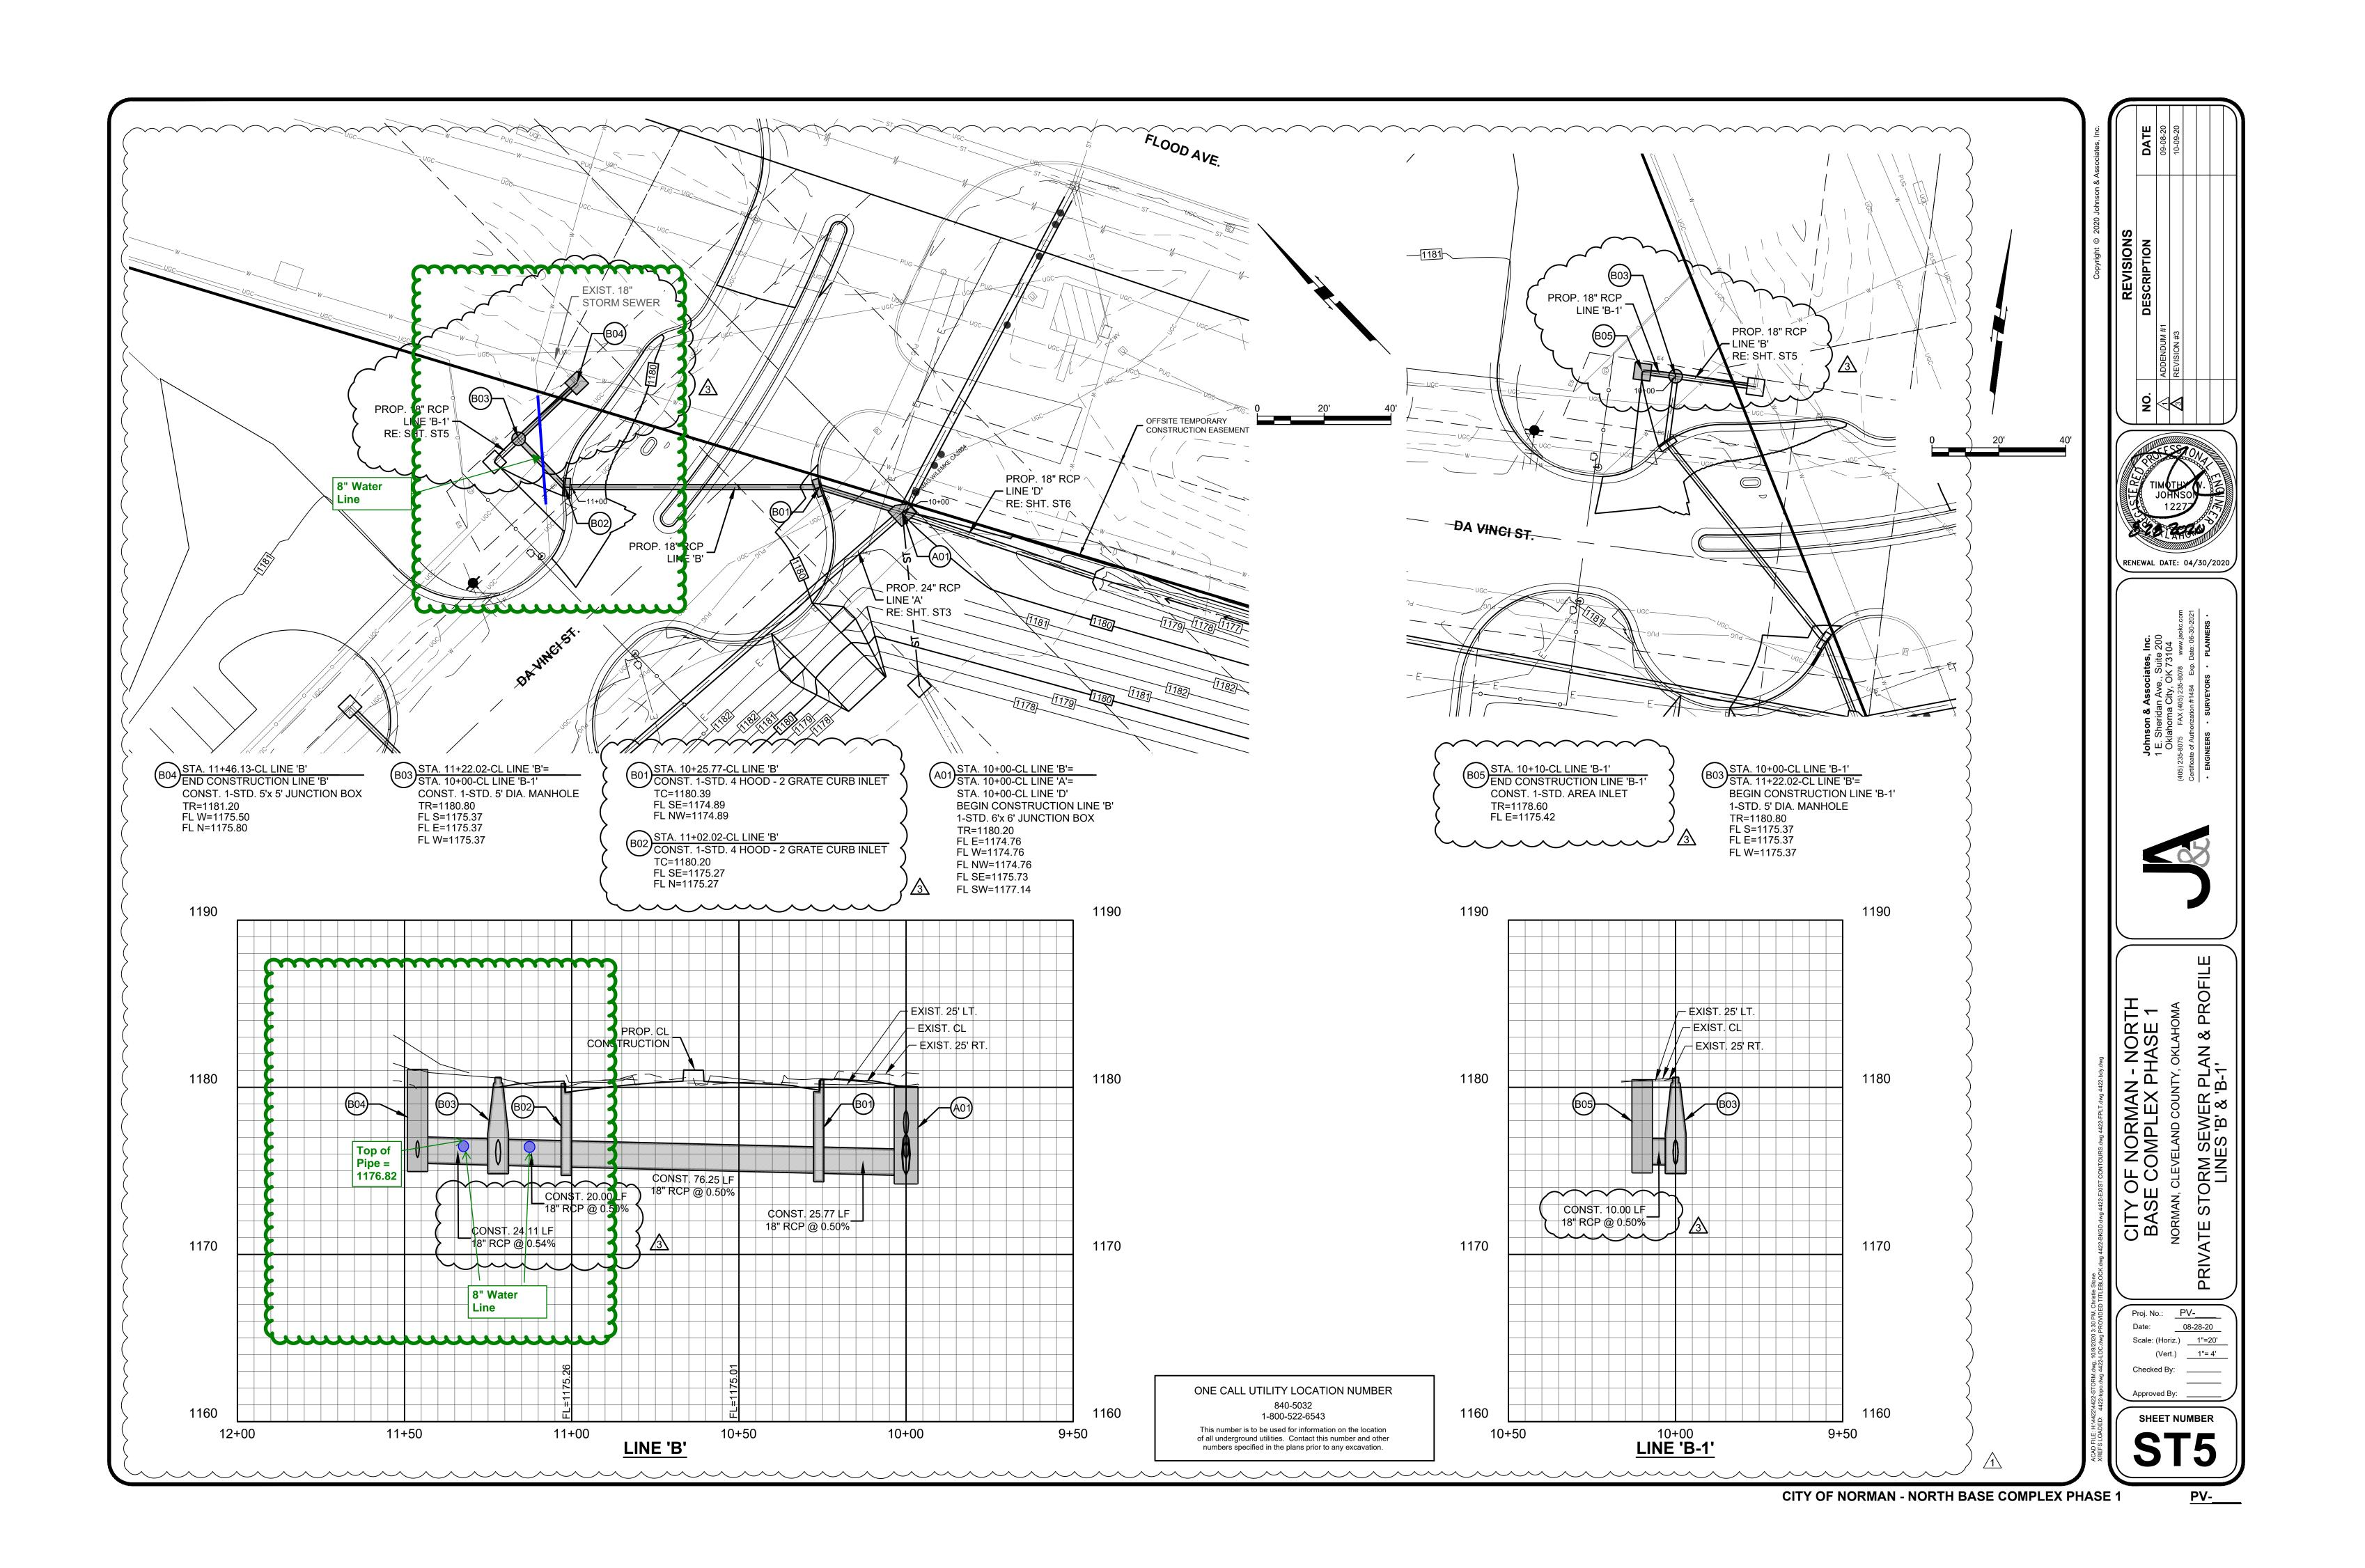



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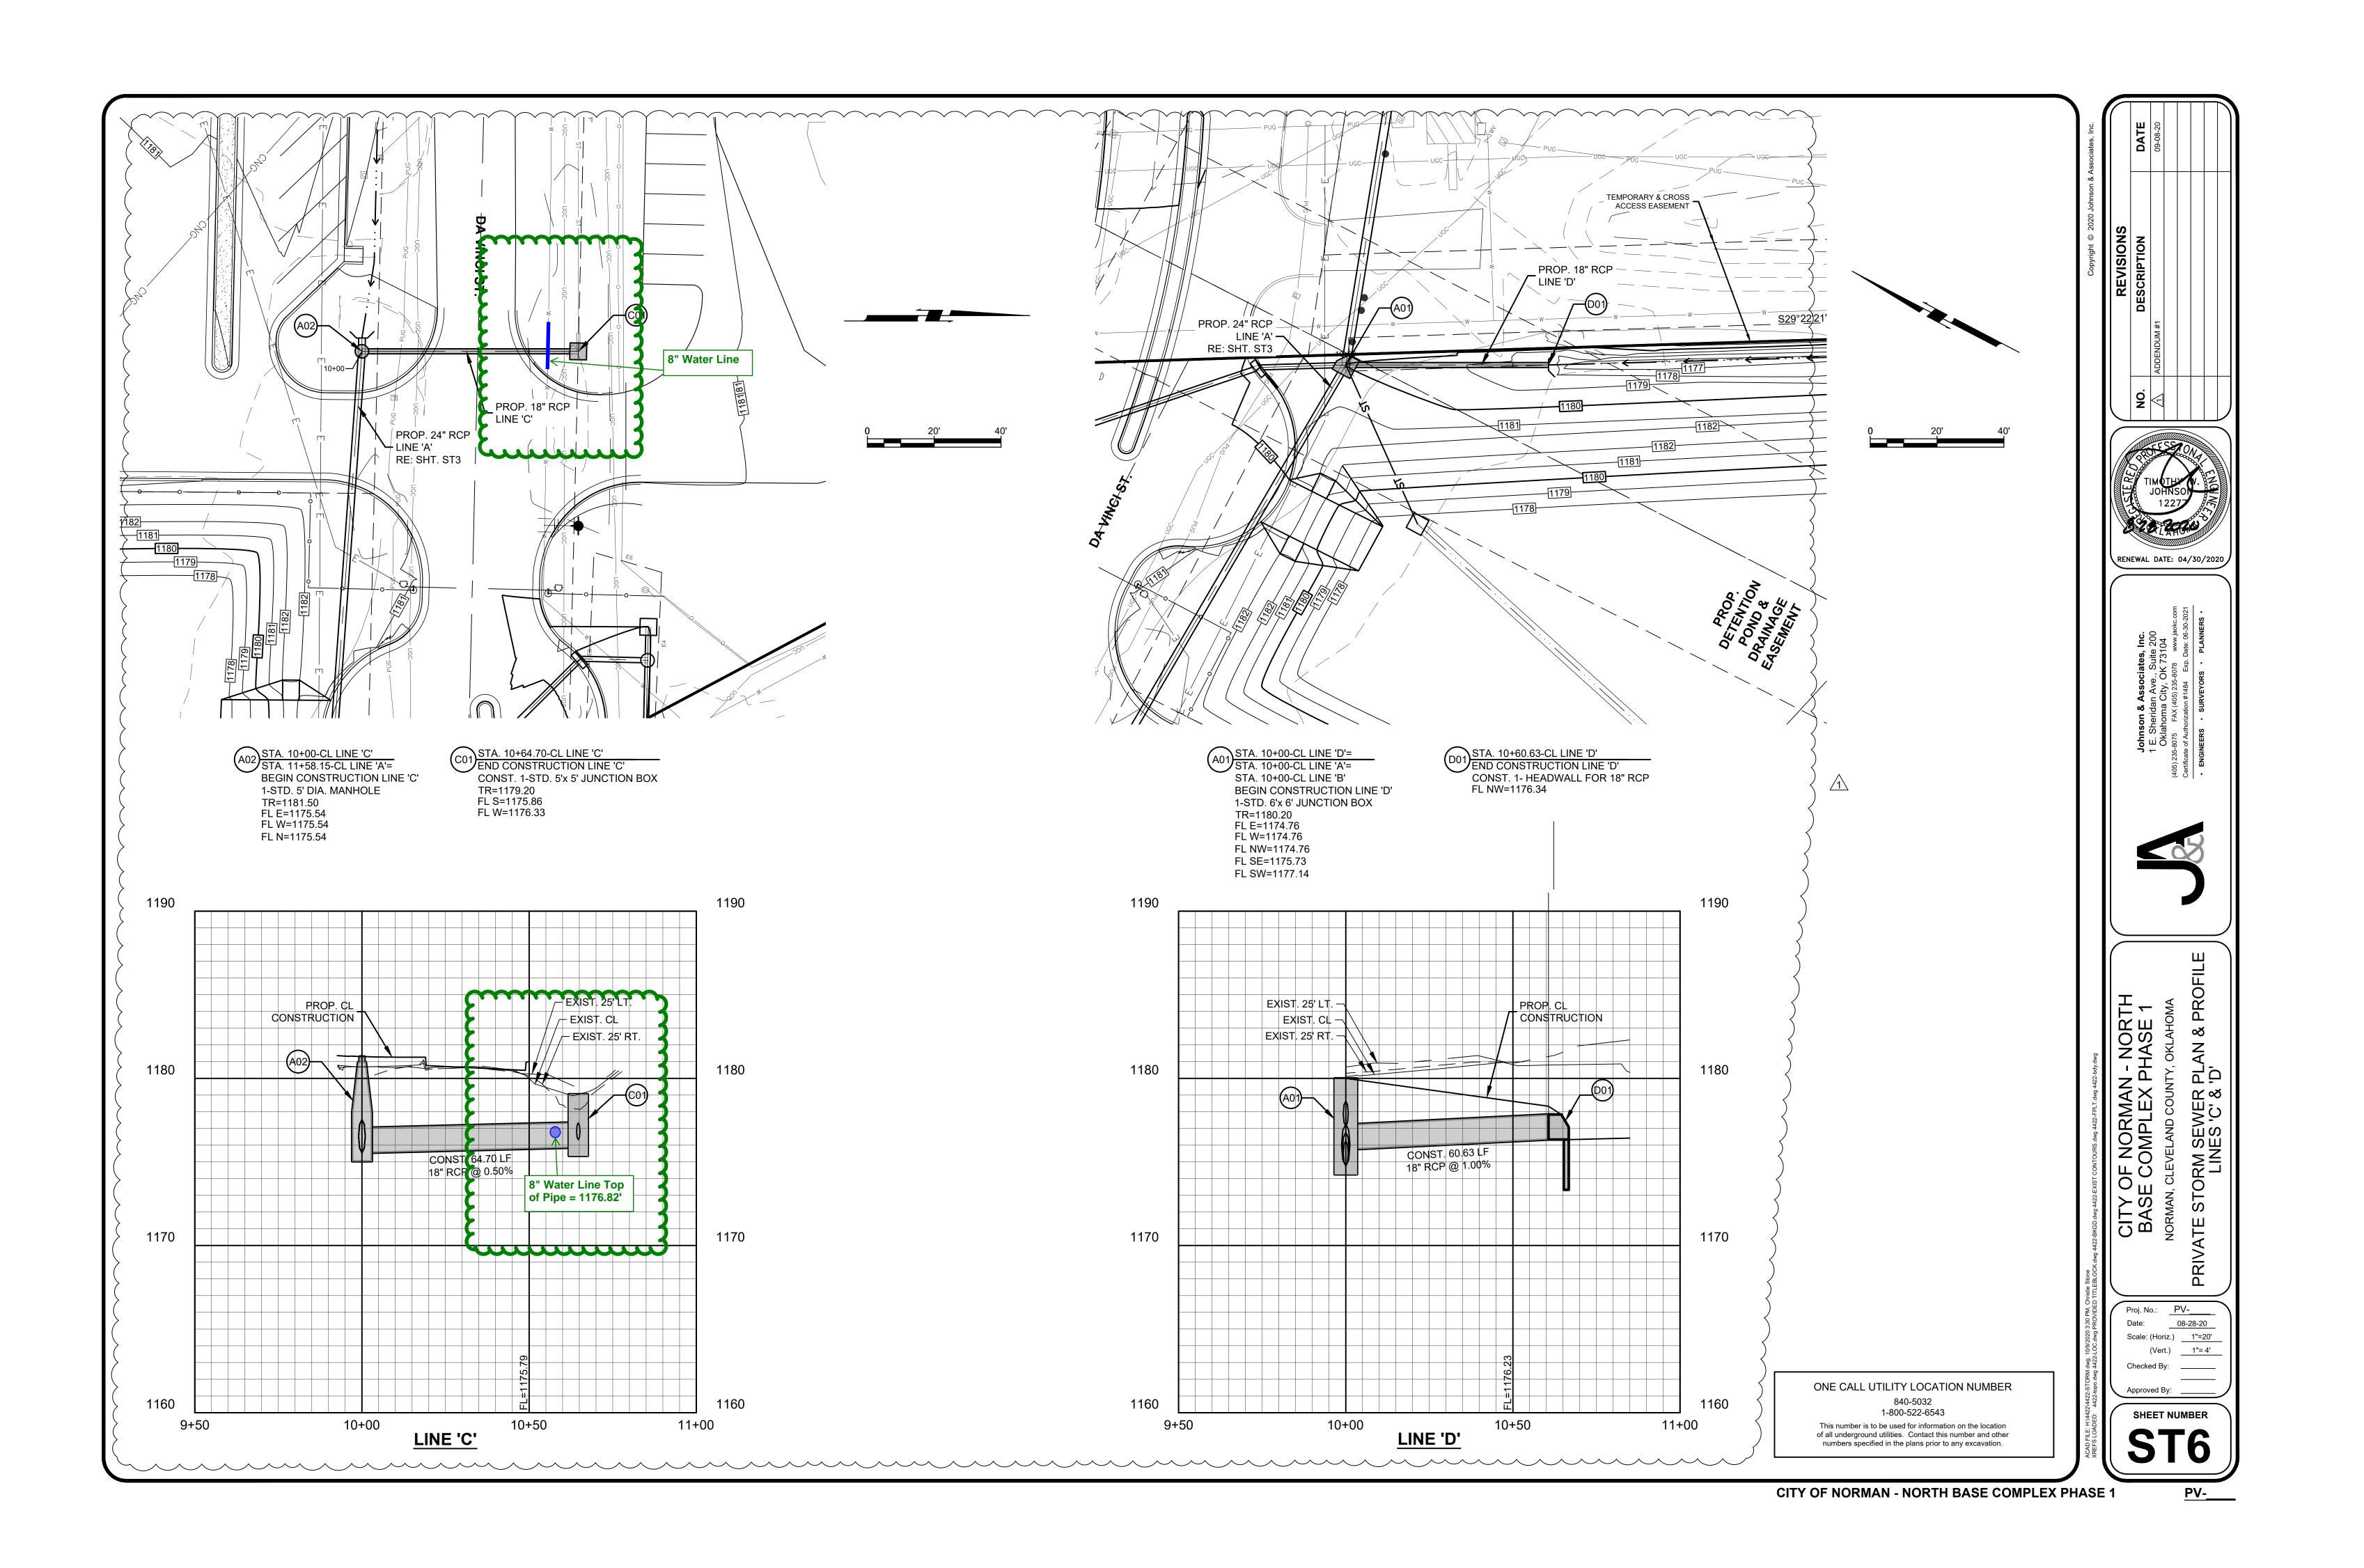


REVISIONS NO. DATE DESCRIPTION

GSB PROJECT NO.

DRAWING TITLE PRIVATE STORM SEWER PLAN & PROFILE 'B'<sub>7</sub>& 'B-1'

DRAWING NO.





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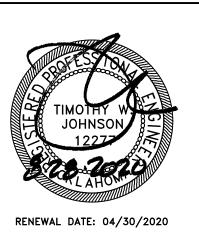
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**REVISIONS** 

NO. DATE DESCRIPTION

GSB PROJECT NO. 191650

DRAWING TITLE PRIVATE STORM SEWER PLAN & PROFILE DATE 'D'

DRAWING NO.

EM NO.	ITEM	UNIT	QUANTITY	AS-BUILT
	WATER LINE QUANTITIES			
1.	6" WATER LINE (C900 PVC)	LF	366	
2.	8"x 6" TAPPING SLEEVE (MJ)	EA	4	
3.	6" TAPPING VALVE & BOX	EA	4	
4.	6"x 6" TEE	EA	_ 2	
5.	6" GATE VALVE & BOX	EA	7	3
6 <u> </u>	6"x 45° BEND	EA .	1	/ /3\
7.	MANHOLE w/ SINGLE DETECTOR CHECK VALVE	EA	3	
8.	FIRE HYDRANT ASSEMBLY	EA	4	
<del></del>	12" RISER (IF REQD)	EA	4	
10.	SINGLE SHORT SERVICE (SSS) (2 1/2")	EA		/3
12.	TYPE 'A' BACKFILL	CY	145 112	
13.	CRUSHED ROCK BEDDING / CRUSHER RUN	CY	70 -54	\ \ \ \
14.	DISINFECTION & TESTING	LS		
15.	METER (2 1/2")	EA	2	
16.	SLS (2 1/2") (DOMESTIC) (PRIVATE)	EA	2	/2\
		<del> </del>		1
	PRIVATE EROSION CONTROL QUANTITIES			
	GRADING CONTRACTOR			
1.	CONSTRUCTION ENTRANCE	EA	1	
2.	SILT FENCE	LF	3470	)
				<b>\</b>
	PAVING CONTRACTOR			<b>\</b>
1.	ROCK BAG FLUME/CURB INLET BARRIER	EA	4	
2.	ROCK BAG CHECK DAM	EA	15	)
3.	SEED ALL DISTURBED AREAS	LS	1	
				1
17.	8" WATER LINE (C900 PVC)	LF	108	
18.	8"x 8" TAPPING SLEEVE (MJ)	EA	4	
19.	8" TAPPING VALVE & BOX	EA	4	
20.	8"x 90° BEND	EA	4	
21.	8"x 45° BEND	EA	2	
22.	8"x 22 1/2° BEND	EA	4	
23.	8" CAP	EA	4	
22. 23.  Origin Source Horize Vertice Bench	8"x 22 1/2° BEND  8" CAP  All Bench Mark:  ie: City of Norman GPS Datum; Oklahoma South ontal Datum: NAD83 ial Datum: NAVD88  in Mark:  150	EA	4	<del>                                     </del>
Northi Eastir Eleva Descr	ng: 2129953.30	e of 12 <sup>th</sup> E of powe	NW,134.2' North er pole and 165'	

 $\overline{\phantom{a}}$ 

On asphalt South mid curve Mendel Pl. and Priestly Ave.

Approximately 410' South of the CL of Einstein St., 15' East of the CL

Approximately 290' North of the CL of Da Vinci St., 150' SW of the CL

of N Flood Ave. and 105' East of the NE corner of building.

Nail with J&A Control Shiner

of Pasteur Ave. and East of South PC drive.

#4 Bar with J&A Control Cap

# PUBLIC WATER LINE PLAN

**TO SERVE** 

# CITY OF NORMAN - NORTH BASE COMPLEX PHASE 1

BEING A PART OF THE NW/4, SEC. 19, T9N, R2W, I.M. & THE NE/4, SEC. 24, T9N, R3W, I.M.

# AN ADDITION TO THE CITY OF NORMAN, CLEVELAND COUNTY, OKLAHOMA

**WATER - GENERAL NOTES** 

ALL CONSTRUCTION SHALL BE DONE IN STRICT ACCORDANCE WITH ORMAN'S "STANDARD SPECIFICATIONS FOR CONSTRUCTION OF PUBLIC MPROVEMENTS" AND SHALL BE UNDER THE STRICT SUPERVISION OF THE CITY ENGINEER OF THE CITY OF NORMAN.

ALL FILL AREAS INDICATED SHALL BE COMPACTED TO 95% STANDARD PROCTOR DENSITY PRIOR TO CONSTRUCTION IN ACCORDANCE WITH THE CITY OF NORMAN'S "STANDARD SPECIFICATIONS FOR CONSTRUCTION OF UBLIC IMPROVEMENTS." TEST REPORTS WILL BE SUBMITTED TO THE ORMAN ENGINEER'S OFFICE.

LL WORK NOT CLASSIFIED AS A "PAY ITEM" SHALL BE CONSIDERED NCIDENTAL CONSTRUCTION, THE COST OF WHICH SHALL BE INCLUDED IN HE COST OF OTHER BID ITEMS.

CONTRACTOR SHALL BE RESPONSIBLE FOR VERIFICATION OF LOCATION OF ALL UTILITIES PRIOR TO EXCAVATION: DAMAGE TO ANY UTILITIES OR TRUCTURE DURING EXCAVATION AND CONSTRUCTION OF PROPOSED WATER MAINS SHALL BE THE RESPONSIBILITY OF THE CONTRACTOR.

RENCHING SHALL BE BACKFILLED WITH TYPE 'A' AGGREGATE UNDER ALL PAVED AREAS. THE CONTRACTOR SHALL BE PAID FOR THE CALCULATED UANTITY OF AGGREGATE REQUIRED TO BACKFILL TRENCHES AS STABLISHED BY THE CITY OF OKLAHOMA CITY STANDARDS AND SPECIFICATIONS FOR TRENCH WIDTH. IF THE CONTRACTOR OVER CUTS THE RENCH. THE ADDITIONAL AGGREGATE WILL BE TREATED AS INCIDENTAL CONSTRUCTION AND WILL BE AT THE CONTRACTOR'S EXPENSE

THERE SHALL BE A MINIMUM OF 4' OF COVER TO THE TOP OF THE PROPOSED WATER LINE.

WHERE NOT INDICATED, WATER LINES SHALL BE A MINIMUM OF 5' FROM PROPERTY LINES AND EASEMENT LINES AND 4' BEHIND BACK OF CURBS.

ALL FIRE HYDRANTS SHALL BE LOCATED A MINIMUM OF 20' FROM BUILDINGS. ALL DUCTILE IRON PIPE FITTINGS AND GLANDS LOCATED IN CORROSIVE SOIL AS DETERMINED BY THE CITY ENGINEER'S 'CORROSIVE SOIL MAP' HALL BE FACTORY APPLIED FUSION BONDED EPOXY COATED (INTERIOR AND EXTERIOR) WHICH MEETS AWWA C-116. THE EPOXY COATING SHALL BE NSTALLED PER THE COATING MANUFACTURERS SPECIFICATIONS. A ERTIFICATE OF COMPLIANCE SHALL BE REQUIRED FROM THE COATING IANUFACTURER STATING THAT THE COATING MEETS ALL REQUIREMENTS IENTIONED HEREIN. HOLIDAY TESTING SHALL BE REQUIRED PER ASTM G . THE EPOXY COATING AND THE FACTORY THAT APPLIES THE COATING HALL BE APPROVED BY THE CITY OF NORMAN. THE FITTING SHALL HAVE IO CEMENT LINING PRIOR TO EPOXY COATING. DUCTILE IRON PIPE NOMINAL VALL THICKNESS SHALL BE 0.34" FOR 12" DIAMETER PIPE, 0.30" FOR 8" DIAMETER PIPE AND 0.28" FOR 6" DIAMETER PIPE.

THE CONTRACTOR SHALL SATISFY HIMSELF AS TO THE ACCURACY OF ALL MEASUREMENTS PRIOR TO CONSTRUCTION OF ANY PERMANENT

11. WATER LINE TESTING AND DISINFECTION SHALL BE DONE IN ACCORDANCE WITH OKLAHOMA DEPARTMENT OF ENVIRONMENTAL QUALITY REGULATIONS, OAC 252:626-19-2.

12. THE CONTRACTOR IS RESPONSIBLE FOR THE PROMPT REPLACEMENT AND/OR REPAIR OF ALL TRAFFIC CONTROL DEVICES AND APPURTENANCES DAMAGED OR DISTURBED DUE TO CONSTRUCTION.

13. THE CONTRACTOR SHALL BE RESPONSIBLE FOR THE REPAIR OR REPLACEMENT OF ALL EROSION CONTROL DEVICES DAMAGED DUE TO CONSTRUCTION.

14. A COPY OF THE EROSION CONTROL SITE PLAN MUST BE ON SITE AT ALL TIMES AND MADE AVAILABLE TO THE INSPECTOR UPON REQUEST.

15. THE CONTRACTOR MAY BE REQUIRED TO INSTALL ADDITIONAL EROSION CONTROL DEVICES BEFORE FLUSHING WATER LINE TO MINIMIZE EROSION AND TO REMAIN IN COMPLIANCE WITH LOCAL AND FEDERAL NPDES PERMIT REQUIREMENTS.

16. CONSTRUCTION ACTIVITIES THAT RESULT IN LAND DISTURBANCE OF EQUAL TO OR GREATER THAN ONE (1) ACRE, OR LESS THAN ONE (1) ACRE IF THEY ARE PART OF A LARGER COMMON PLAN OF DEVELOPMENT OR SALE THAT TOTALS AT LEAST ONE (1) ACRE MUST ALSO OBTAIN A PERMIT FROM ODEQ (FORM 605-002a) FOR STORM WATER DISCHARGES FROM CONSTRUCTION

ACTIVITIES. THIS MEANS THAT LAND DISTURBING OF ONE (1) ACRE OR MORE MUST PERMIT WITH ODEQ AND THE CITY OF NORMAN, STORM WATER

17. THE CONTRACTOR SHALL DISPOSE OF WATER FLUSHED FROM THE LINES TO A LOCATION APPROVED BY THE CITY ENGINEER OR DESIGNATED

18. A WORK ZONE PERMIT MUST BE OBTAINED FROM THE TRAFFIC MANAGEMENT DIVISION AT LEAST TWO (2) WORKING DAYS PRIOR TO THE START OF WORK AND/OR PLACING OR REMOVING ANY BARRICADES OR MODIFYING EXISTING TRAFFIC CONTROL DEVICES. E-MAIL workzones@okc.gov TO OBTAIN AN APPLICATION.

9. IN ACCORDANCE WITH ODEQ REGULATIONS, THE CITY PROVIDES WATER AT A MINIMUM PRESSURE OF 25 psi. THE DEVELOPER IS RESPONSIBLE FOR DESIGNING AND CONSTRUCTION OF ALL FIXTURES TO PROVIDE ADEQUATE DOMESTIC AND FIRE PROTECTION UNDER MINIMUM PRESSURE CONDITIONS. THE DEVELOPER WILL BE RESPONSIBLE FOR ANY FAILURE OF DOMESTIC AND FIRE PROTECTION SYSTEMS WHICH REQUIRE WATER PRESSURE IN EXCESS OF 25 psi.

20. THE LOCATION OF THE FDC AS SHOWN ON THESE PLANS IS NOT APPROVED AS PART OF THESE PLANS. LOCATION OF THE FDC MUST BE COORDINATED THROUGH & APPROVED BY THE FIRE MARSHALL.

21. ALL PROPOSED WATER METERS AND FIRE HYDRANTS TO BE LOCATED OUTSIDE OF THE PROPOSED SIDEWALK.

22. CONTRACTOR SHALL INCLUDE ALL COSTS FOR METER AND INSTALLATION IN BID. INSPECTION FEES WILL BE WAIVED. PERMIT SHALL BE REQUIRED.

POLYVINYL CHLORIDE PIPE (PVC) INSTALLATION NOTES PIPE - PVC PRESSURE PIPE SHALL BE AWWA C-900, PRESSURE CLASS

200 AND WITH A MINIMUM DIMENSION RATIO ØF EIGHTEEN (DR-18). FITTINGS - FITTINGS SHALL BE MECHANICAL JOINT TYPE AS SPECIFIED UNDER DUCTILE IRON FITTINGS. ALL FITTINGS SHALL HAVE POLYETHYLENE ENCASEMENT TUBING WITH A THICKNESS OF 8 WIL. SEE WATER - GENERAL NOTE 9

TRACER WIRE (ONE #12 SHALL BE PLACED ON TOP OF PVC PIPE), A WEATHER HEAD AND 5F GALVANIC ANODE'S SPACED AT 500 FT INTERVALS SHALL BE PROVIDED AS SHOWN ON CITY OF NORMAN STANDARD NO. W11. SEE DETAIL SHT. WF5.

 $\frac{\sqrt{3}}{\sqrt{3}}$ JOINT RESTRAINTS - THE JOINTS SHALL BE RESTRAINED USING CONCRETE THRUST BLOCK AND MECHANICAL JOINT RESTRAINT FOR AWWA C-900. JOINT RESTRAINTS SHALL BE MANUFACTURED BY EBBA IRON SALES, INC., OR UNI-FLANGE BY THE FORD METER BOX CO., INC., OR APPROVED EQUAL.

WATER SERVICE CONNECTIONS - WATER SERVICE CONNECTIONS SHALL BE STAINLESS STEEL SADDLE AND GASKET.

6. PIPE BEDDING - SEE DETAIL SHT. WF5

### BILLING ADDRESS CITY OF NORMAN

201A W. GRAY ST. NORMAN, OK 73069

# BUILDING ADDRESS:

CITY OF NORMAN 201A W. GRAY ST. NORMAN, OK 73069

The City of NORMAN R 3 W R 2 W ROCK CREEK RD. **PROJECT LOCATION** ROBINSON ST. **LOCATION MAP** SCALE: 1"=2000' SHEET INDEX SHEET No. **DESCRIPTION** TITLE SHEET, QUANTITIES WF2 PUBLIC WATER LINE GENERAL LAYOUT WF3-WF4 PUBLIC WATER LINE PLAN & PROFILE PUBLIC WATER LINE PLAN & PROFILE ONE CALL UTILITY LOCATION NUMBER 840-5032 This number is to be used for information on the location of all underground utilities. Contact this number and other 1-800-522-6543 numbers specified in the plans prior to any excavation. SUBMITTAL DATES TO NORMAN PREPARED BY: 08-28-20 CHECK PRINT #1 8.28.2020 HECK PRINT #2 DATE TIMOTHY W JOHN Reg. P.E. No. 12277 INAL PLANS CONSTRUCTION MUST BEGIN WITHIN TWO (2) YEAR FROM THE DATE OF APPROVAL, OR THAT APPROVAL IS WITHDRAWN. DEPARTMENT OF PUBLIC WORKS **ENGINEERING DIVISION** Date: Field Checked by: Date: Checked by: Date: Checked by: Johnson & Associates, Inc.

Checked by: Date: 1 E. Sheridan Ave., Suite 200 Oklahoma City, OK 73104 (405) 235-8075 FAX (405) 235-8078 www.jaokc.com Certificate of Authorization #1484 Exp. Date: 06-30-202 • ENGINEERS • SURVEYORS • PLANNERS •

City Engineer

BLDC-

**GSB PROJECT NO.** 

DRAWING TITLE

OWNER

CITY OF NORMAN, OKLAHOMA 201 A WEST GRAY STREET NORMAN, OKLAHOMA 73069

3555 NW 58th Street, Suite 700V Oklahoma City, OK 73112

**JOHNSON & ASSOCIATES** 

WALLACE ENGINEERING

M/ P/ FP ENGINEER ALLEN CONSULTING, INC 110 NORTH MERCEDES DRIVE

NORMAN, OK 73069 (405) 928-7702

www.acimep.com

(405) 801-2528

www.haeinc.com

(918) 628-1255

OKLAHOMA CITY, OK 73104

**ELECTRICAL ENGINEER** 

NORMAN, OKLAHOMA 73071

TULSA, OKLAHOMA 74135

www.planningdesigngroup.com

Oklahoma City, OK 7311

405.848.9549

405.848.9783

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RENEWAL DATE: 04/30/2020

REVISIONS

DATE DESCRIPTION

LANDSCAPE ARCHITECT PLANNING DESIGN GROUP 5314 SOUTH YALE AVE - STE. 510

1306 COMMERCE DRIVE

HORNER ASSOCIATES ENGINEERS

1 EAST SHERIDAN AVE.- STE. 200

STRUCTURAL ENGINEER

OKLAHOMA CITY, OKLAHOMA 73104

410 NORTH WALNUT AVE. - STE. 200

www.NormanOK.gov

ARCHITECT

(405) 848-9549 www/gsb-inc.com CIVIL ENGINEER

(405) 235-8075

(405) 236-5858 www.wallacesc.com

PUBLIC WATER LINE TITLESHEET

08-28-20

DRAWING NO.

ACAD FILE: H:\4422\4422-WATER.dwg, 1/22/2021 12:27 PM, Christie Stone XREFS LOADED: 4422-topo.dwg PROVIDED TITLEBLOCK.dwg 4422-BKGD.dwg 4422-bdy.dwg 4422-EXIST CONTOURS.dwg 4422-FPLT.dwg 4422-LOC.dwg

Bench Marks by Johnson & Associates

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694953.98

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696030.62

2129848.27

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Cut X

2128792.73

Set On/Around Site:

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Easting:

Elevation:

Description:

Bench Mark #

Northing:

Elevation:

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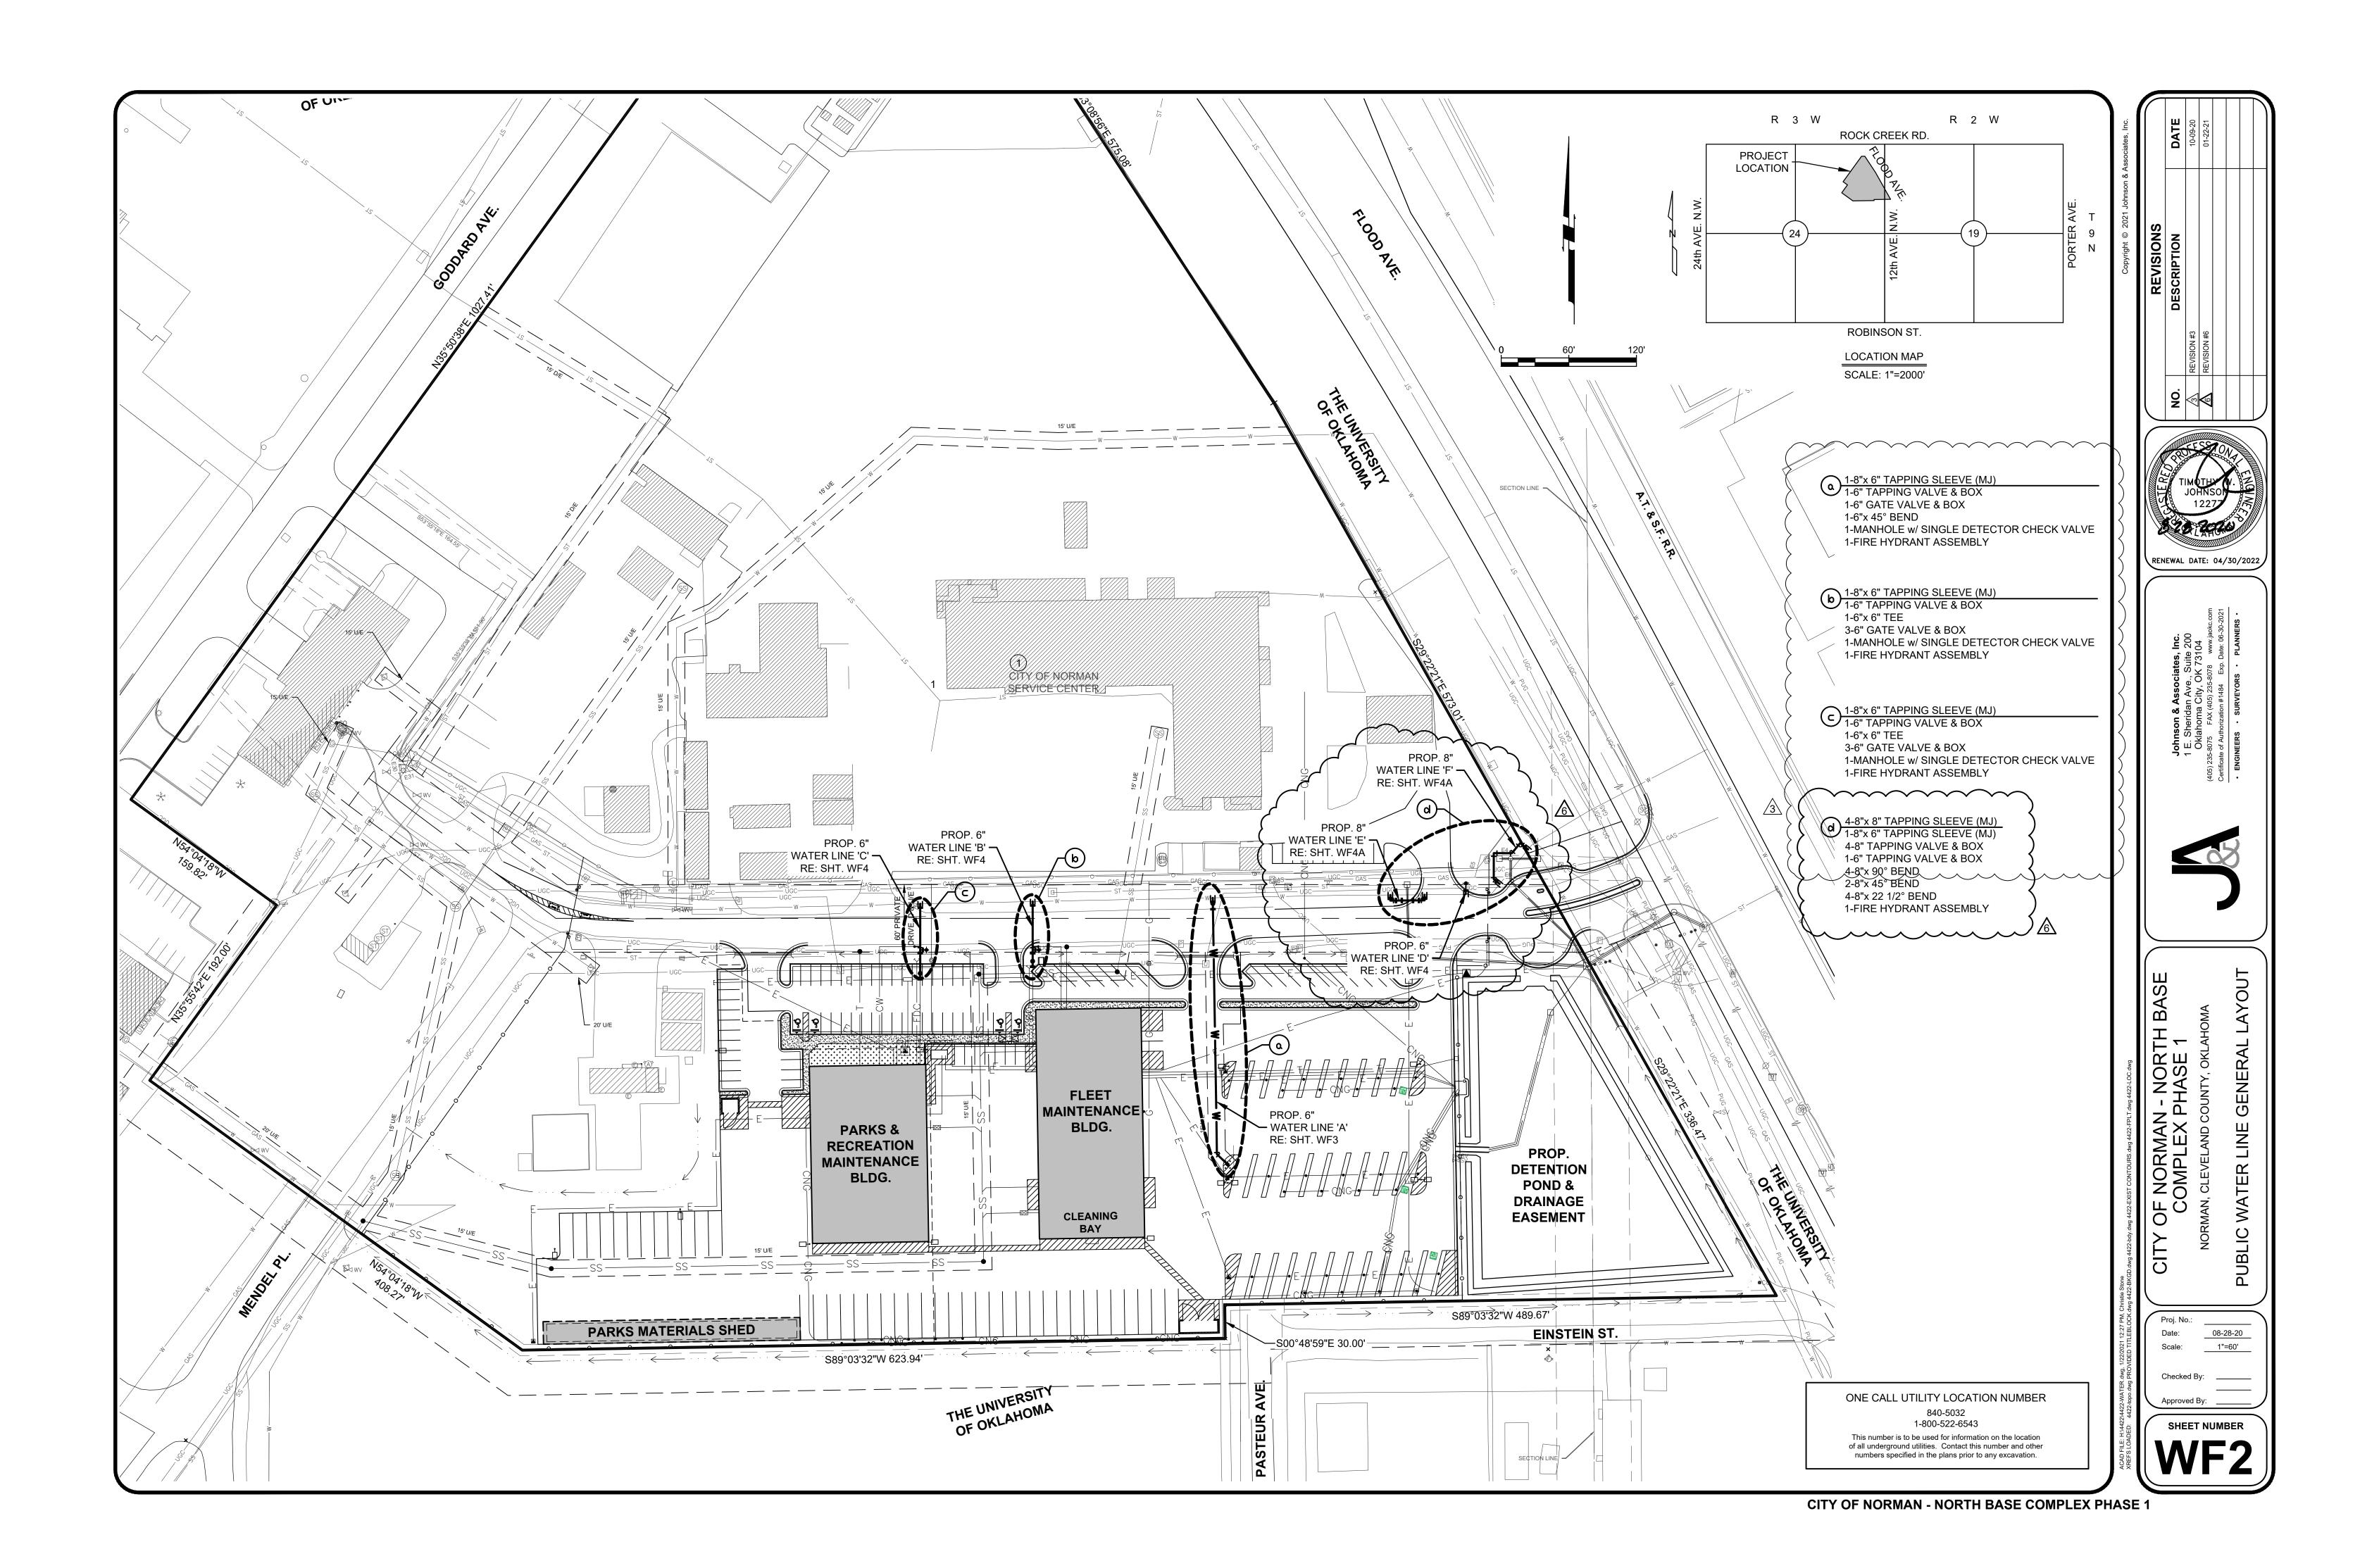
Elevation:

Description:

Easting:

Object:

CITY OF NORMAN - NORTH BASE COMPLEX PHASE 1





ARCHITECT GSB, INC

3555 NW 58th Street, Suite 700W Oklahoma City, OK 73112 (405) 848-9549 www/gsb-inc.com CIVIL ENGINEER

JOHNSON & ASSOCIATES 1 EAST SHERIDAN AVE.- STE. 200 OKLAHOMA CITY, OKLAHOMA 73104 (405) 235-8075

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www.acimep.com ELECTRICAL ENGINEER HORNER ASSOCIATES ENGINEERS

1306 COMMERCE DRIVE NORMAN, OKLAHOMA 73071 (405) 801-2528 www.haeinc.com

LANDSCAPE ARCHITECT 5314 SOUTH YALE AVE - STE. 510

PLANNING DESIGN GROUP TULSA, OKLAHOMA 74135 (918) 628-1255 www.planningdesigngroup.com



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REVISIONS

NO. DATE DESCRIPTION


GSB PROJECT NO.

DRAWING TITLE PUBLIC WATER LINE GENERAL LAYOUT

08-28-20

DRAWING NO.

WF2

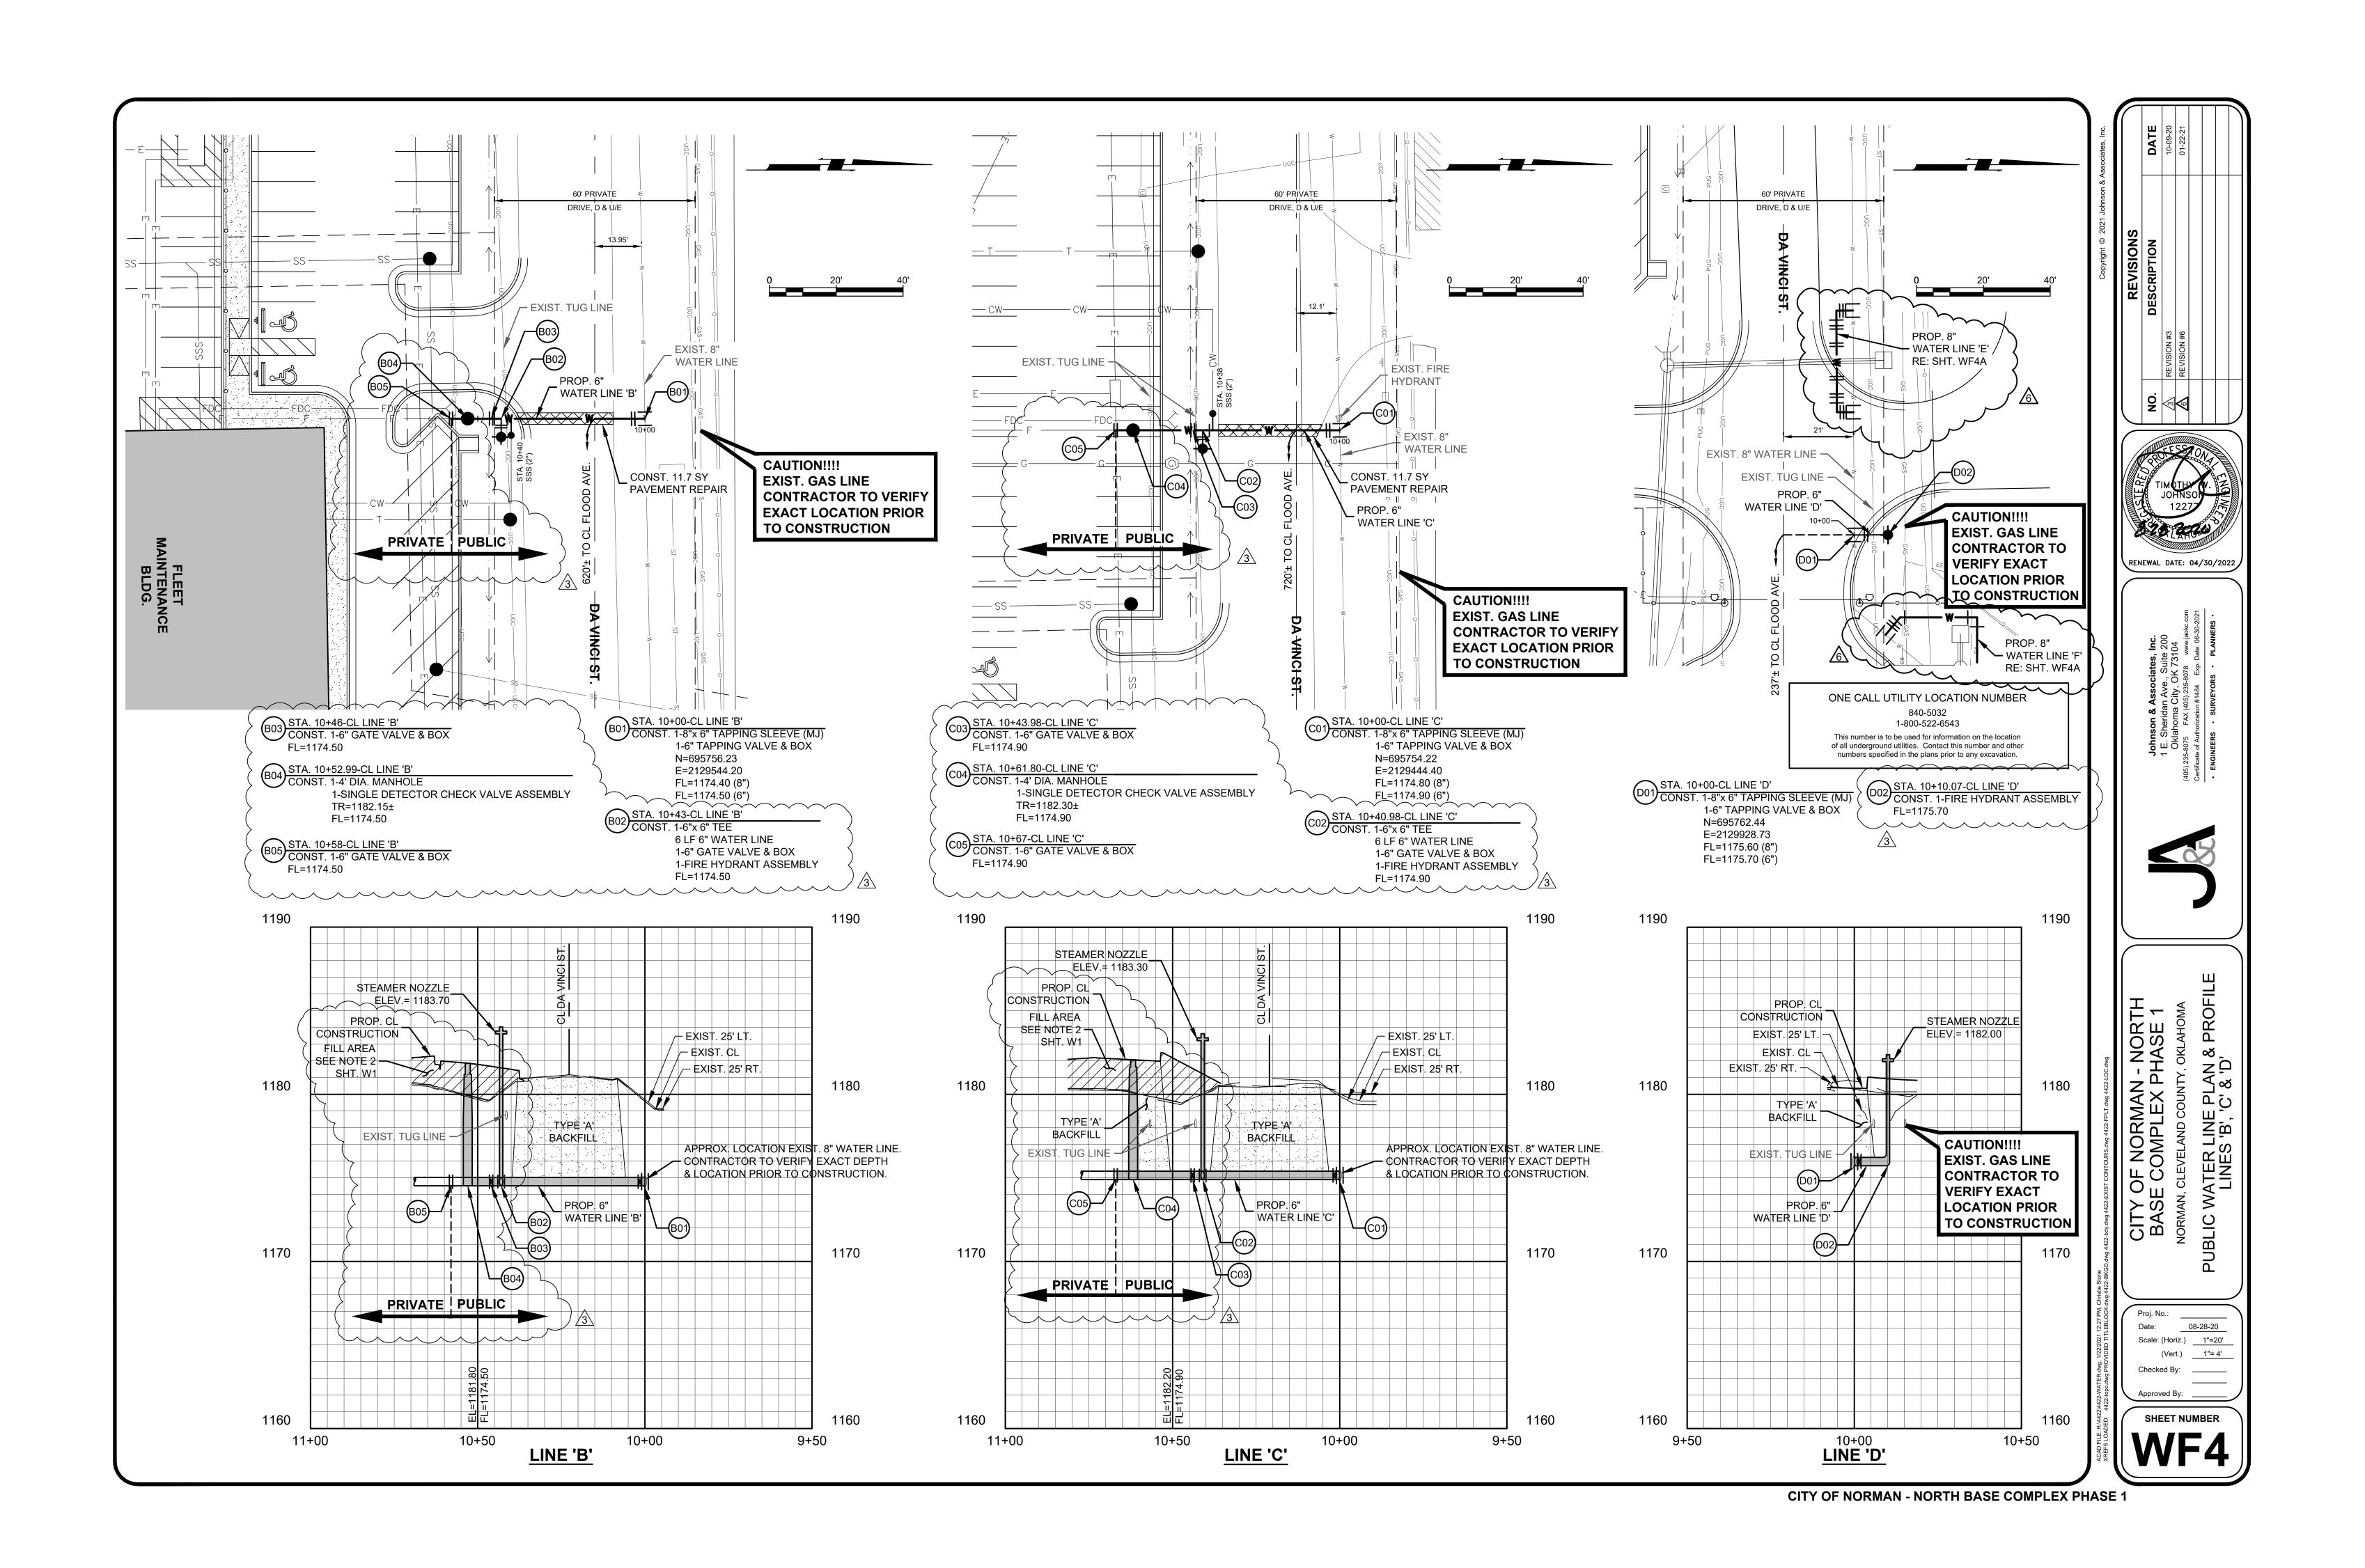



OWNER

(405) 366-5406 www.NormanOK.gov

ARCHITECT GSB, INC

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(405) 235-8075 www.jaokc.com

(405) 236-5858 www.wallacesc.com

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3555 NW 58th Street, Suite 700W Oklahoma City, OK 73112

JOHNSON & ASSOCIATES 1 EAST SHERIDAN AVE.- STE. 200 OKLAHOMA CITY, OKLAHOMA 73104

WALLACE ENGINEERING

M/ P/ FP ENGINEER ALLEN CONSULTING, INC. 110 NORTH MERCEDES DRIVE

NORMAN, OK 73069 (405) 928-7702 www.acimep.com

OKLAHOMA CITY, OK 73104

**ELECTRICAL ENGINEER** HORNER ASSOCIATES ENGINEERS

NORMAN, OKLAHOMA 73071

LANDSCAPE ARCHITECT

PLANNING DESIGN GROUP 5314 SOUTH YALE AVE - STE. 510

1306 COMMERCE DRIVE

(405) 801-2528 www.haeinc.com


STRUCTURAL ENGINEER

410 NORTH WALNUT AVE. - STE. 200

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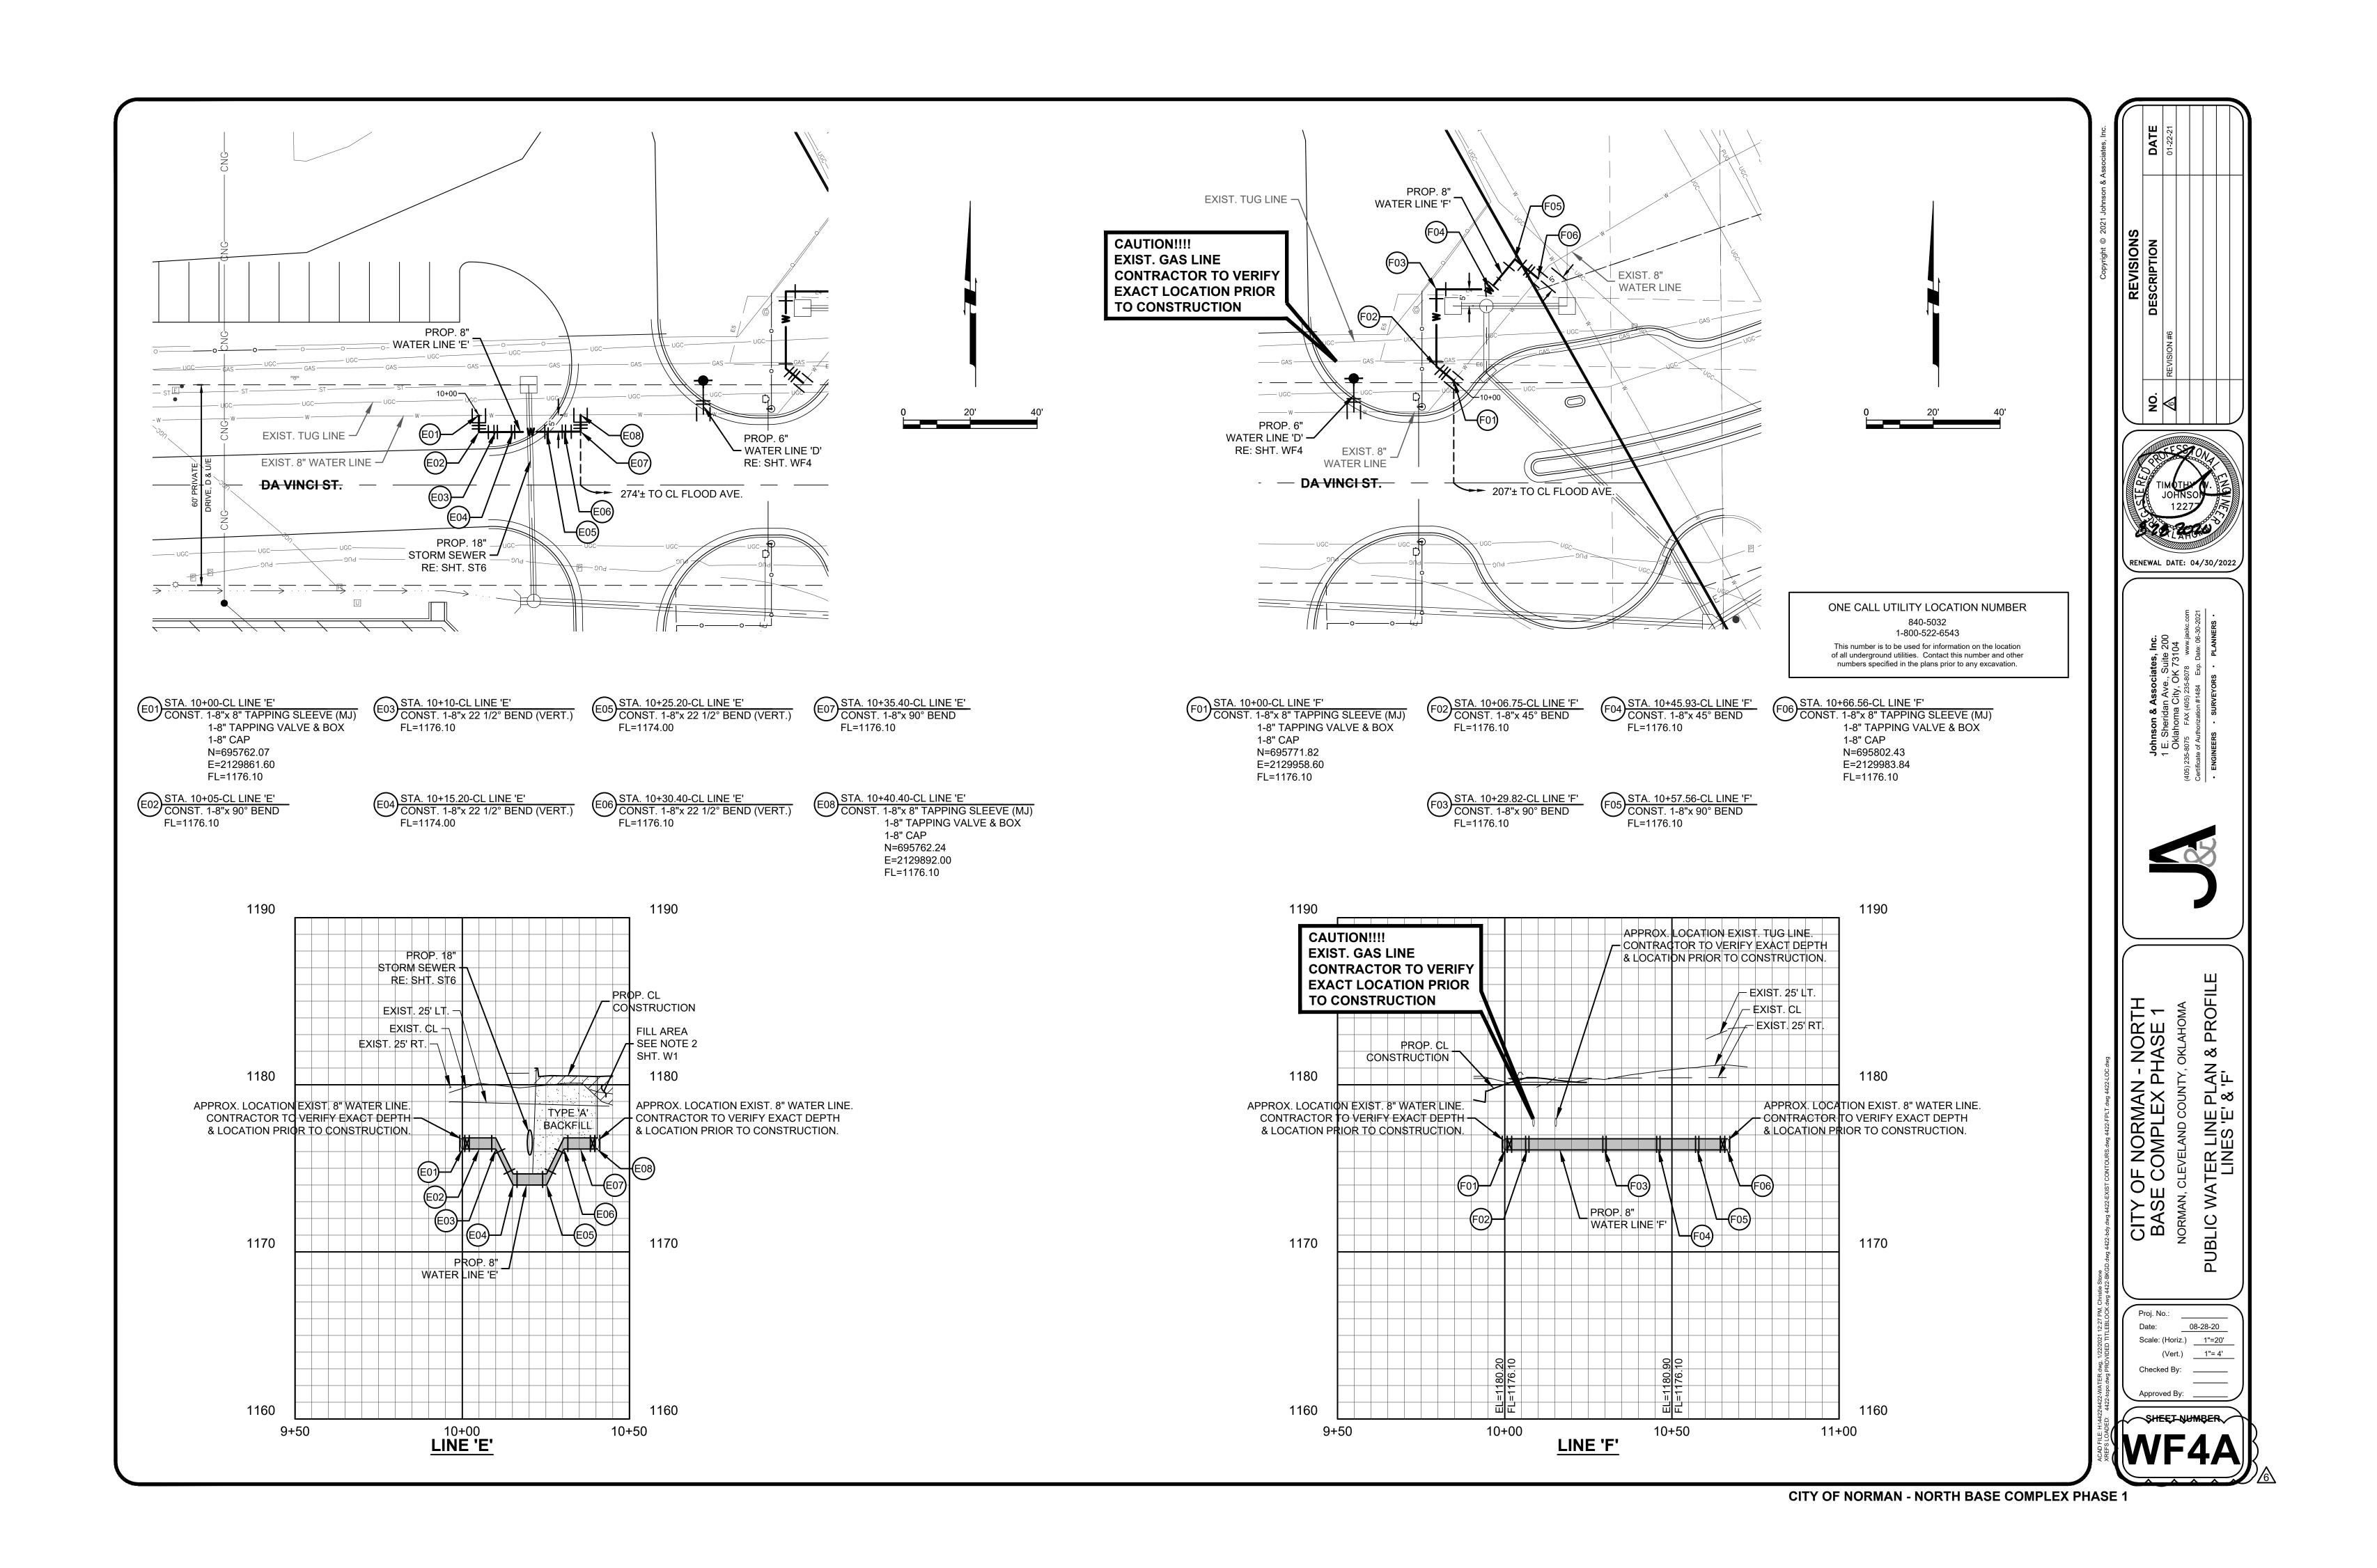
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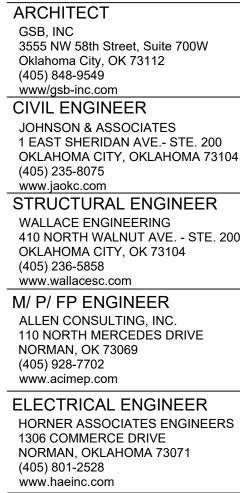
DRAWING TITLE
PUBLIC WATER LINE
PLAN & PROFILE LINES 'B', 'C' & 'D'

08-28-20

DRAWING NO.

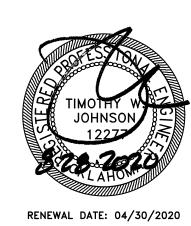WF4





LANDSCAPE ARCHITECT PLANNING DESIGN GROUP 5314 SOUTH YALE AVE - STE. 510

TULSA, OKLAHOMA 74135

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OWNER

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CITY OF NORMAN, OKLAHOMA 201 A WEST GRAY STREET NORMAN, OKLAHOMA 73069

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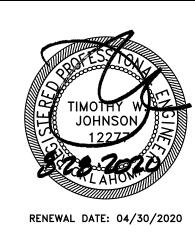
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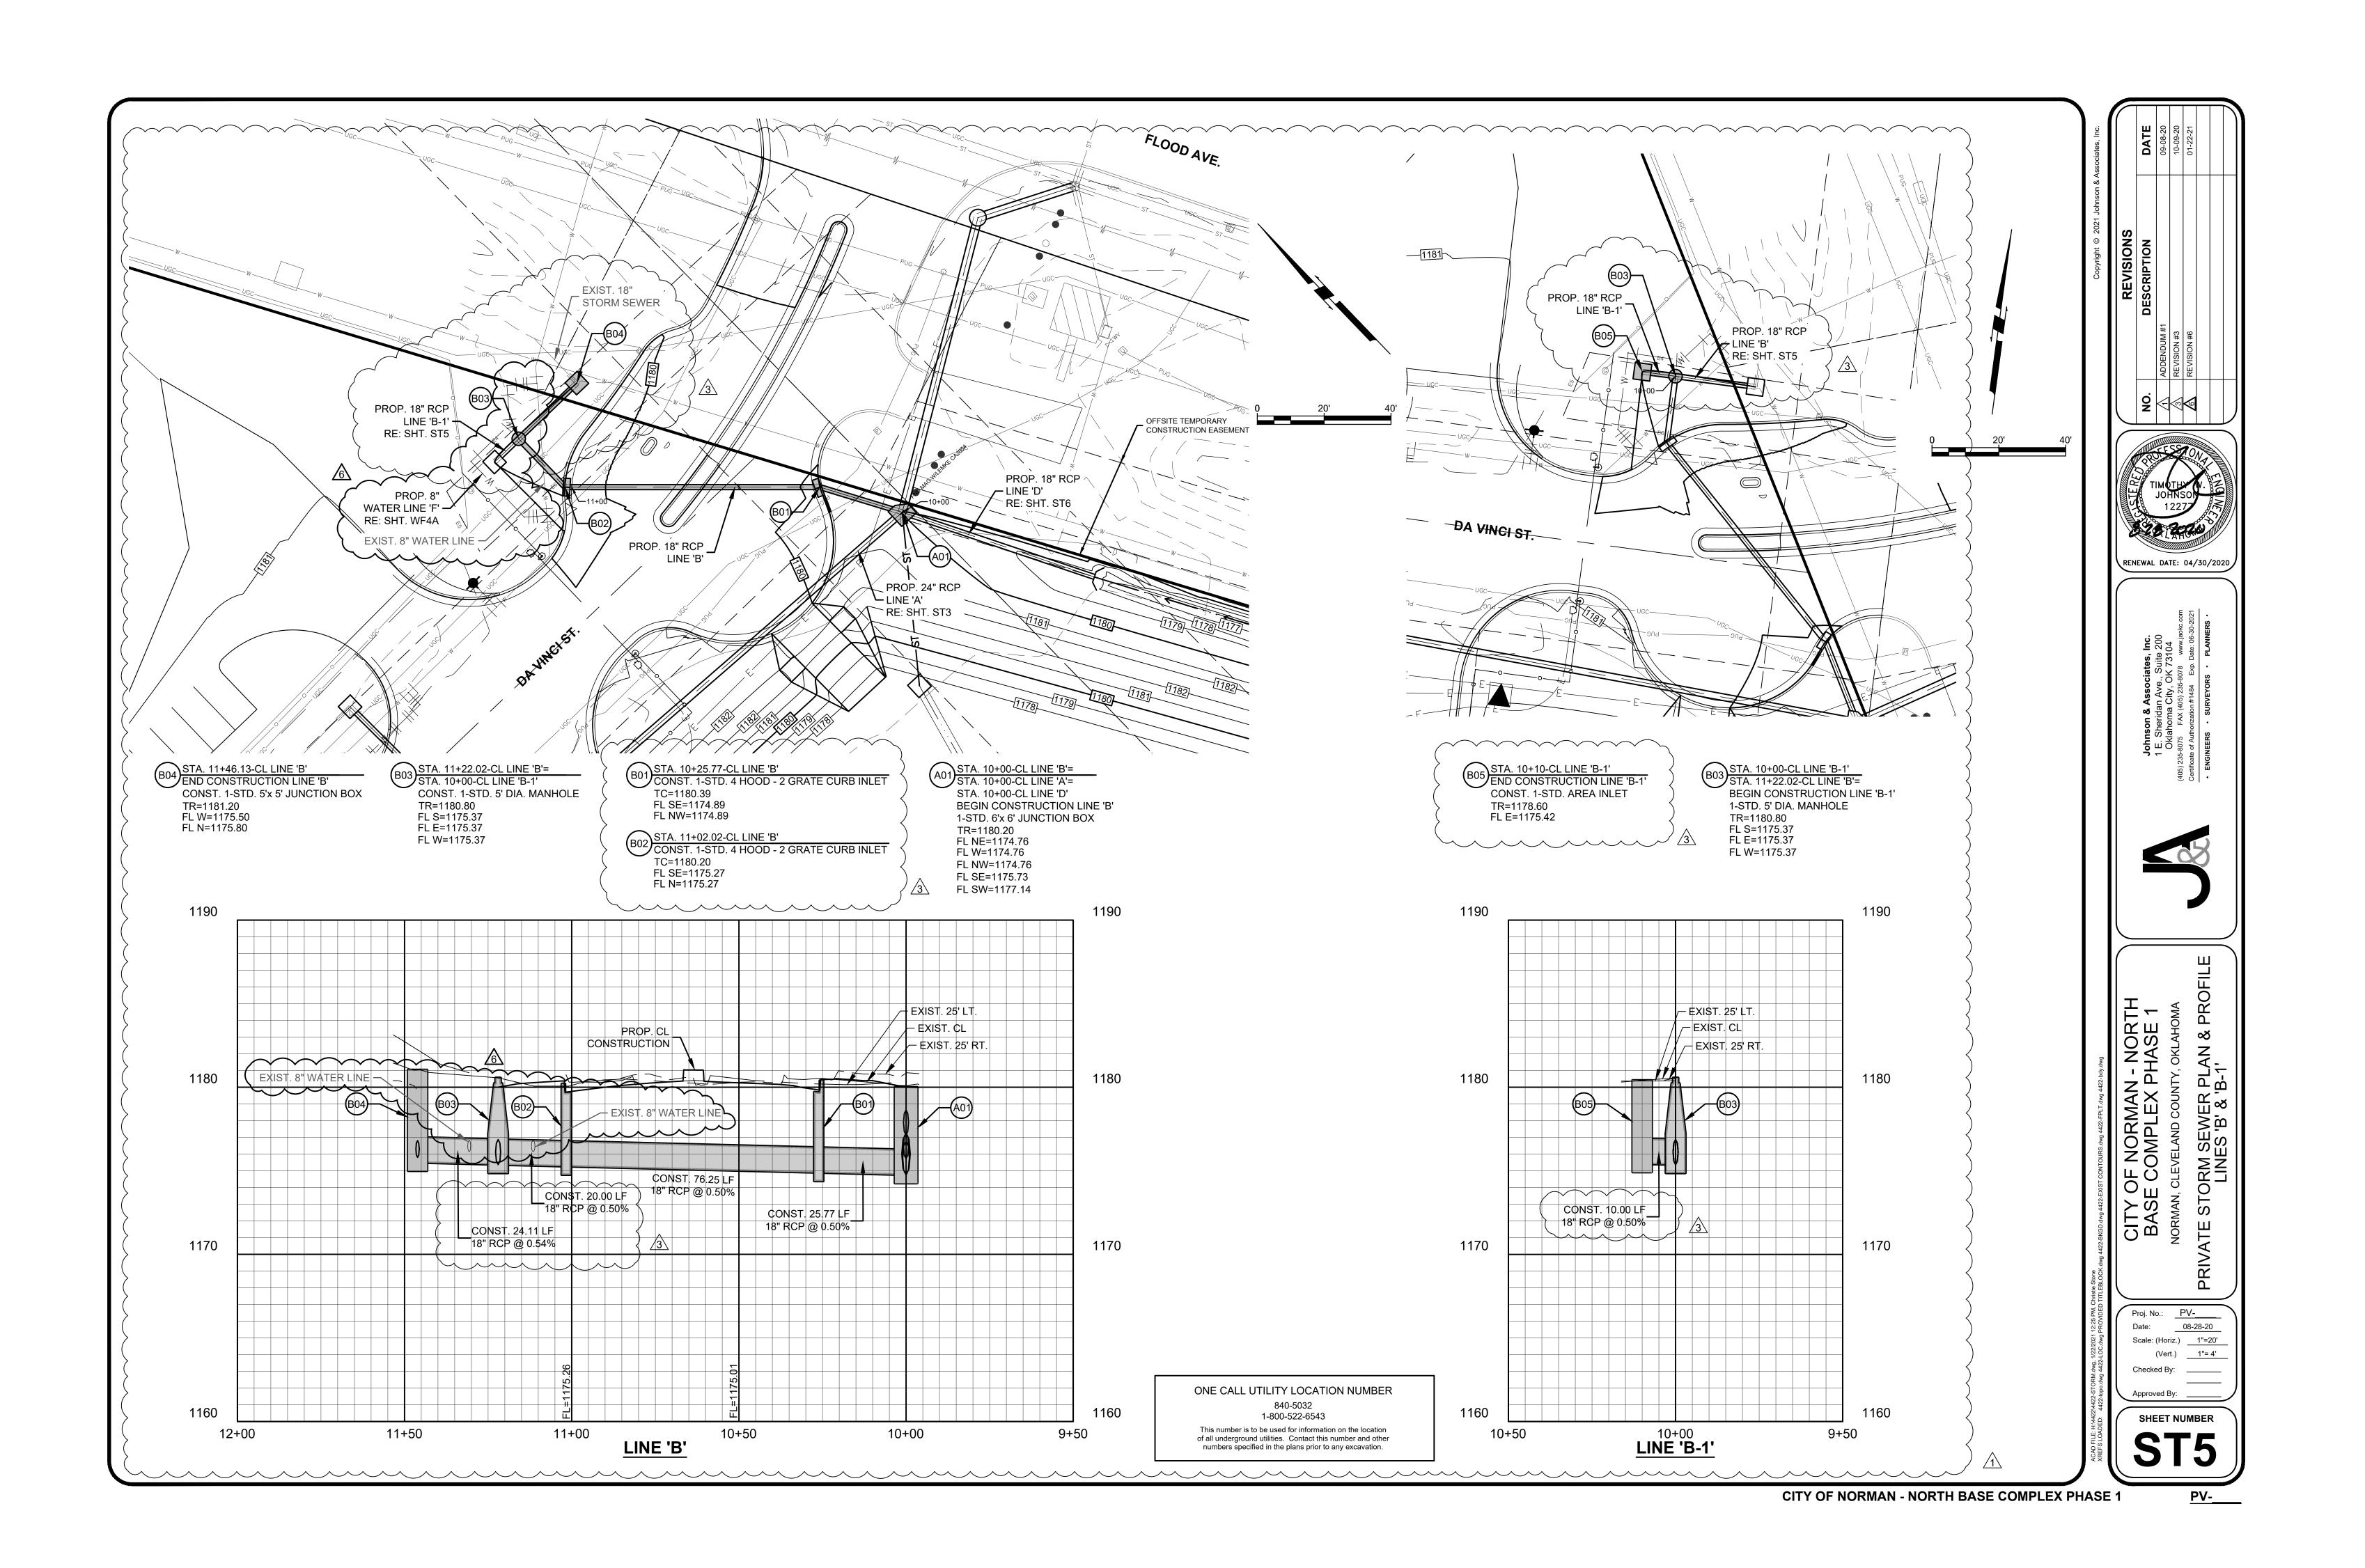
REVISIONS					
NO.	DATE	DESCRIPTION			

GSB PROJECT NO. 191650

08-28-20

DRAWING TITLE PUBLIC WATER LINE PLAN & PROFILE LINES 'E' & 'F'

DRAWING NO.





OWNER CITY OF NORMAN, OKLAHOMA 201 A WEST GRAY STREET NORMAN, OKLAHOMA 73069 (405) 366-5406 www.NormanOK.gov

ARCHITECT GSB, INC 3555 NW 58th Street, Suite 700W Oklahoma City, OK 73112 (405) 848-9549

www/gsb-inc.com CIVIL ENGINEER JOHNSON & ASSOCIATES 1 EAST SHERIDAN AVE.- STE. 200

OKLAHOMA CITY, OKLAHOMA 73104 (405) 235-8075 www.jaokc.com STRUCTURAL ENGINEER WALLACE ENGINEERING 410 NORTH WALNUT AVE. - STE. 200

OKLAHOMA CITY, OK 73104 (405) 236-5858 www.wallacesc.com M/ P/ FP ENGINEER ALLEN CONSULTING, INC. 110 NORTH MERCEDES DRIVE

NORMAN, OK 73069 (405) 928-7702 www.acimep.com

ELECTRICAL ENGINEER HORNER ASSOCIATES ENGINEERS 1306 COMMERCE DRIVE NORMAN, OKLAHOMA 73071

(405) 801-2528 www.haeinc.com LANDSCAPE ARCHITECT PLANNING DESIGN GROUP 5314 SOUTH YALE AVE - STE. 510 TULSA, OKLAHOMA 74135


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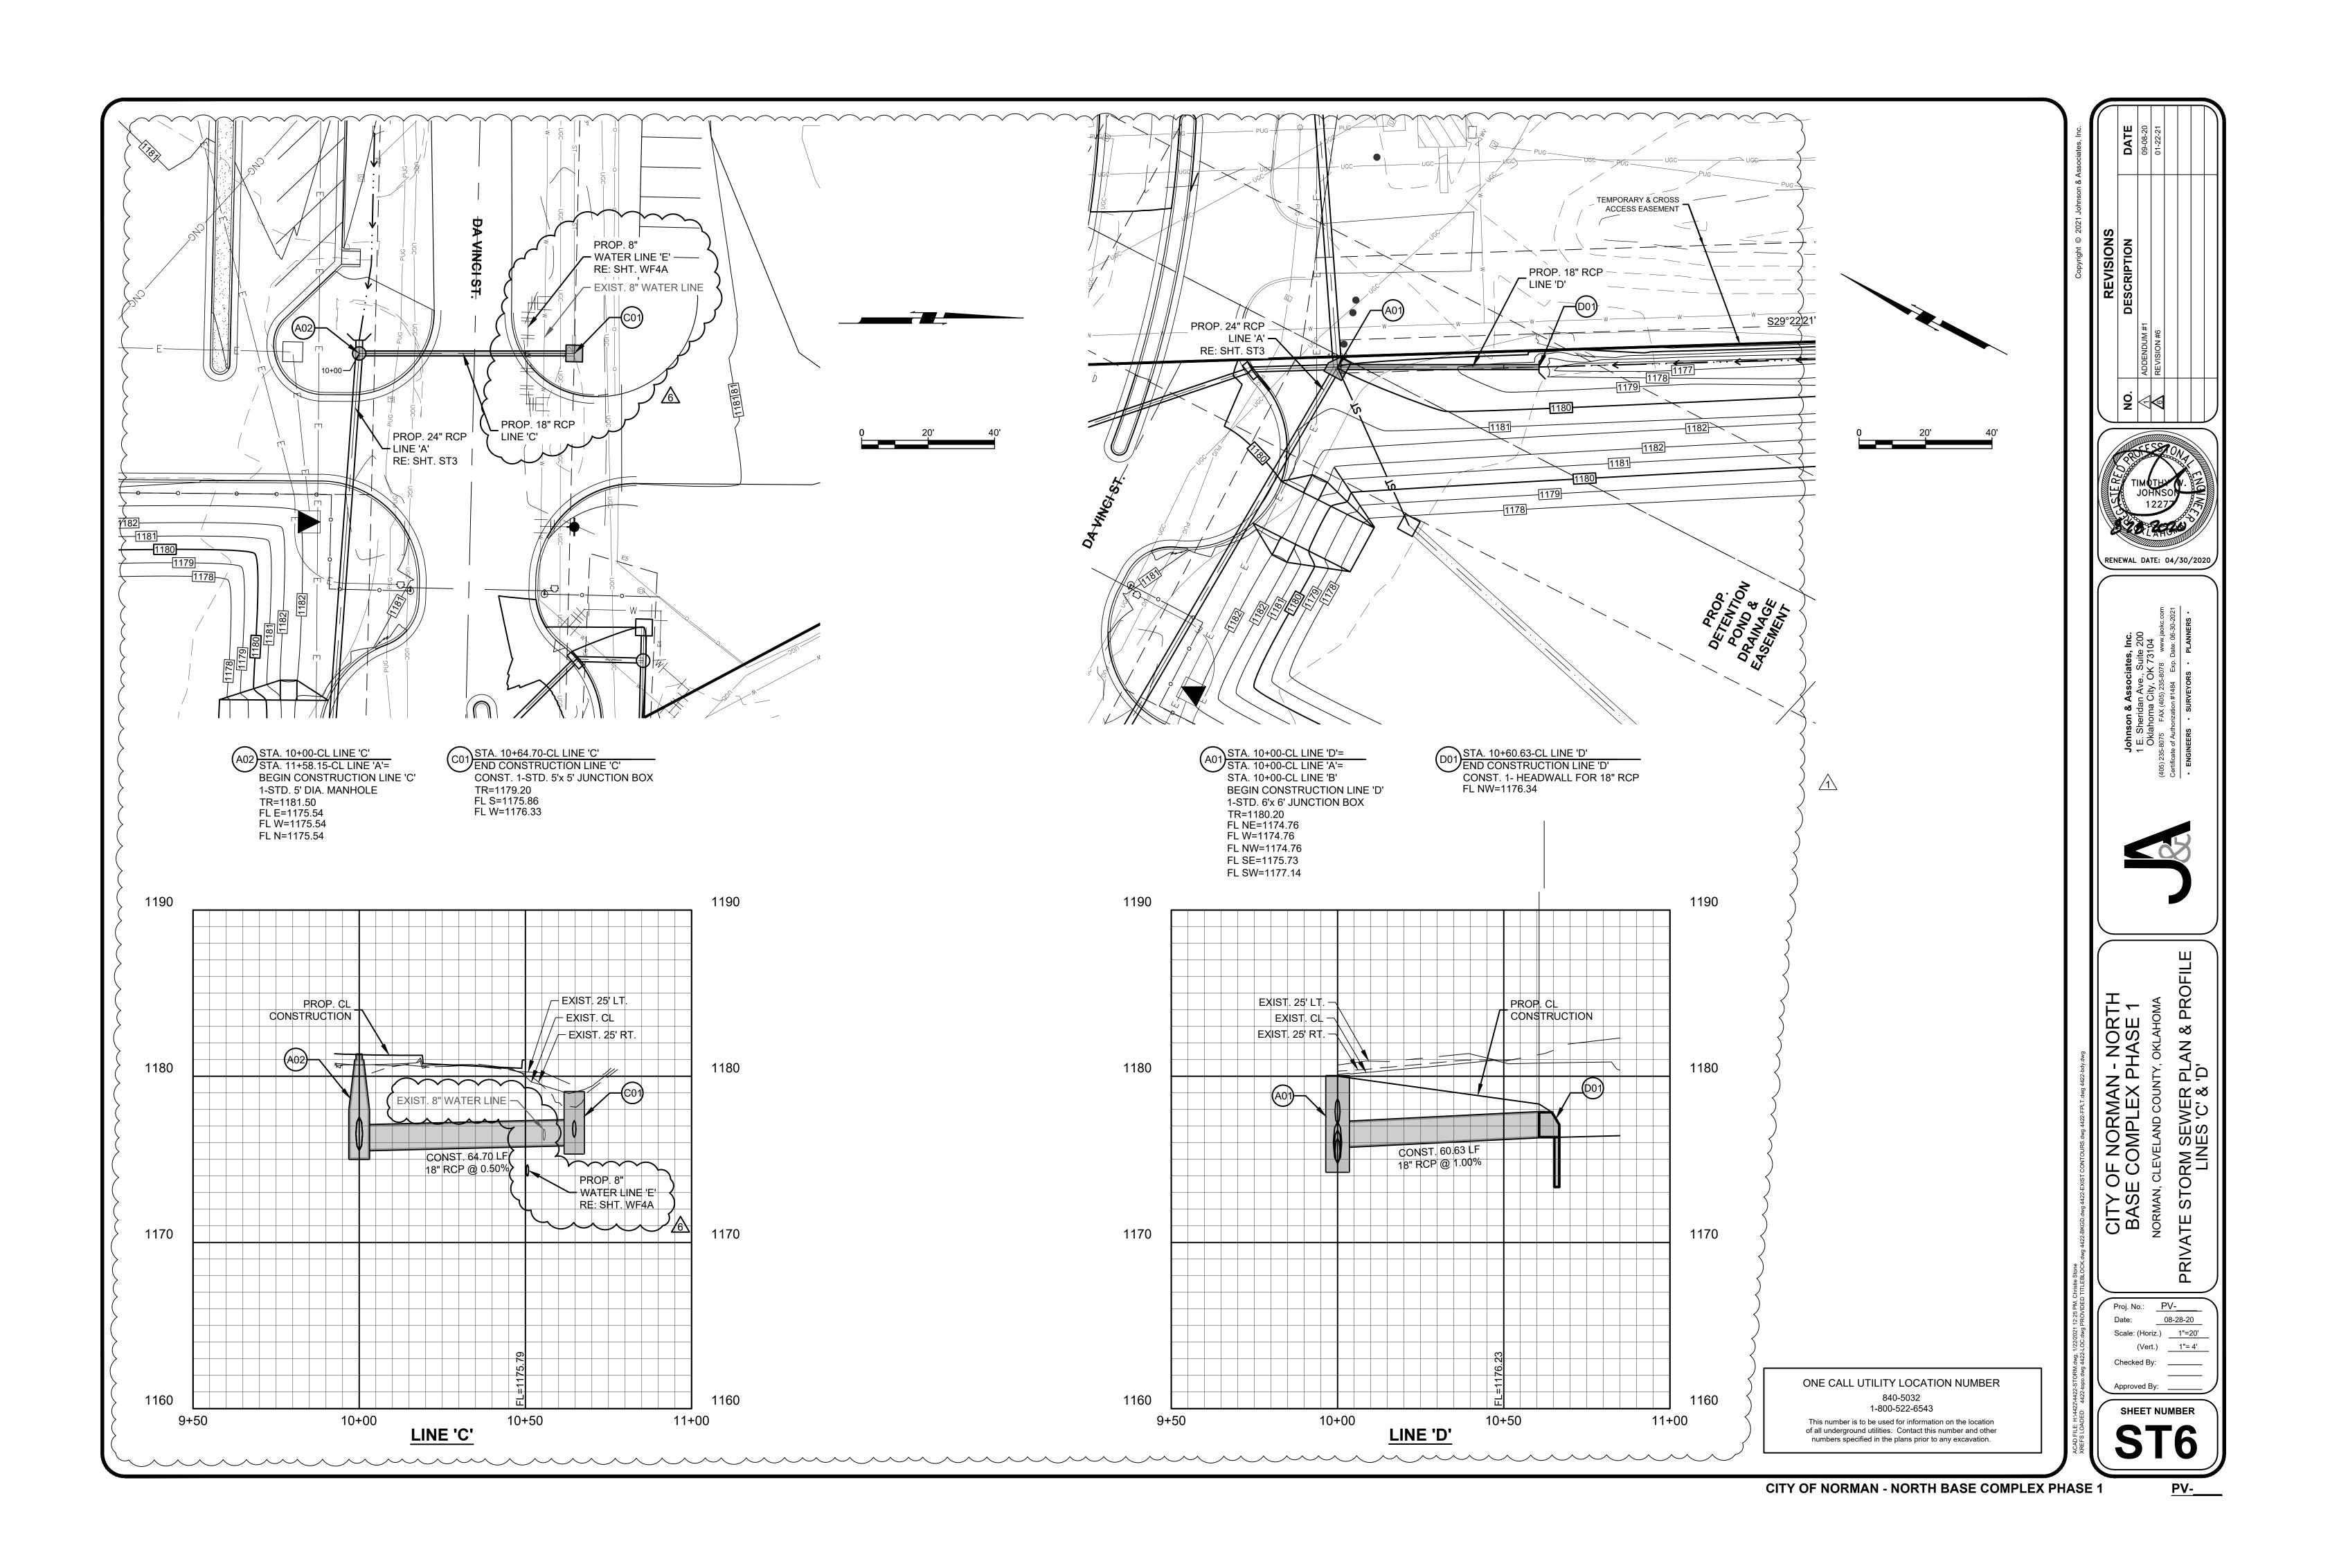


REVISIONS NO. DATE DESCRIPTION

GSB PROJECT NO.

DRAWING TITLE PRIVATE STORM SEWER PLAN & PROFILE L 'B'<sub>T</sub>& 'B-1'

DRAWING NO.

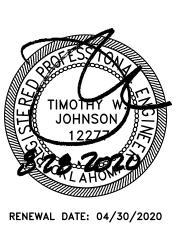



OWNER CITY OF NORMAN, OKLAHOMA 201 A WEST GRAY STREET NORMAN, OKLAHOMA 73069 (405) 366-5406 www.NormanOK.gov

ARCHITECT GSB, INC 3555 NW 58th Street, Suite 700W Oklahoma City, OK 73112 (405) 848-9549

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(405) 236-5858 www.wallacesc.com M/ P/ FP ENGINEER ALLEN CONSULTING, INC. 110 NORTH MERCEDES DRIVE NORMAN, OK 73069

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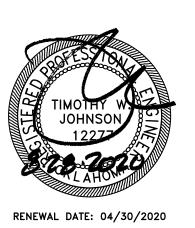
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REVISIONS NO. DATE DESCRIPTION

GSB PROJECT NO. 191650

DRAWING TITLE PRIVATE STORM SEWER PLAN & PROFILE DATE 'D'

DRAWING NO.

TEM NO.	ITEM	UNIT	QUANTITY	AS-BUILT
	WATER LINE QUANTITIES			
1.	6" WATER LINE (C900 PVC)	LF	366	
2.	8"x 6" TAPPING SLEEVE (MJ)	EA	4	
3.	6" TAPPING VALVE & BOX	EA	4	
4.	6"x 6" TEE	EA	2	_
5.	6" GATE VALVE & BOX	EA	7	$\sqrt{3}$
6	6"x 45° BEND	EA		$\frac{\circ}{\circ}$
7.	MANHOLE W/ SINGLE DETECTOR CHECK VALVE	EA	3	
8.	FIRE HYDRANT ASSEMBLY	EA	4	
9.	12" RISER (IF REQD)	EA	4	_ {
10.	SINGLE SHORT SERVICE (SSS) (2 1/2")	, EA		$\sqrt{3}$
12.	TYPE 'A' BACKFILL	CY	145 -112	<del></del>
13.	CRUSHED ROCK BEDDING / CRUSHER RUN	CY	70 <del>54</del>	<u> </u>
14.	DISINFECTION & TESTING	LS		<del></del>
15.	MĚTEŘ (2 1/2")	EĂ	2	
16.	SLS (2 1/2") (DOMESTIC) (PRIVATE)	EA	2	$\langle \underline{2} \rangle$
		<b>\</b>		$\sim$
>	PRIVATE EROSION CONTROL QUANTITIES			
>				
<i>,</i> >	GRADING CONTRACTOR			
1.	CONSTRUCTION ENTRANCE	EA	1	
2.	SILT FENCE	LF	3470	
	DAY/NG CONTRACTOR			<del></del>
·	PAVING CONTRACTOR			<u> </u>
<del>)</del> 1.	ROCK BAG FLUME/CURB INLET BARRIER	EA	4	
2.	ROCK BAG CHECK DAM	EA	15	
3.	SEED ALL DISTURBED AREAS	LS	1	$\overline{}$
				$\sim$
17.	8" WATER LINE (C900 PVC)	LF	108	
18.	8"x 8" TAPPING SLEEVE (MJ)	EA	4	$\overline{}$
19.	8" TAPPING VALVE & BOX	EA	4	<del></del>
20.	8"x 90° BEND	EA	4	)
21.	8"x 45° BEND	EA	2	<u> </u>
22.	8"x 22 1/2° BEND	EA	4	$\overline{}$
23.	8" CAP	EA	4	<u> </u>
<u>_</u> ^	·			<b>√</b> 6\

#### Original Bench Mark: Source: City of Norman GPS Datum; Oklahoma South Horizontal Datum: NAD83 Vertical Datum: NAVD88

Bench Mark: 150 697192.37 Northing: Easting: 2129953.30 1171.90 Elevation:

Approximately 60.6' West of the West edge of 12<sup>th</sup> NW,134.2' North Description: of north edge of Rock Creek Rd., 186.3' NE of power pole and 165'

SW of traffic sign 2" Diameter Aluminum Cap Monument Object:

### Bench Marks by Johnson & Associates

Set On/Around Site:

Bench Mark # 400 695278.08 Northing: 2128792.73 Easting:

1178.38 Elevation: On asphalt South mid curve Mendel Pl. and Priestly Ave. Description: Nail with J&A Control Shiner Object:

Bench Mark # 401 694953.98 Northing: 2129765.85 Easting:

Elevation: Description: Approximately 410' South of the CL of Einstein St., 15' East of the CL

of Pasteur Ave. and East of South PC drive.

Object: #4 Bar with J&A Control Cap

Bench Mark # 405 696030.62 Northing: 2129848.27 Easting:

Elevation: 1181.14 Description:

Approximately 290' North of the CL of Da Vinci St., 150' SW of the CL of N Flood Ave. and 105' East of the NE corner of building.

Object: Cut X

## PUBLIC WATER LINE PLAN

**TO SERVE** 

## CITY OF NORMAN - NORTH BASE COMPLEX PHASE 1

BEING A PART OF THE NW/4, SEC. 19, T9N, R2W, I.M. & THE NE/4, SEC. 24, T9N, R3W, I.M.

### AN ADDITION TO THE CITY OF NORMAN, CLEVELAND COUNTY, OKLAHOMA

**WATER - GENERAL NOTES** 

ALL CONSTRUCTION SHALL BE DONE IN STRICT ACCORDANCE WITH NORMAN'S "STANDARD SPECIFICATIONS FOR CONSTRUCTION OF PUBLIC IMPROVEMENTS" AND SHALL BE UNDER THE STRICT SUPERVISION OF THE CITY ENGINEER OF THE CITY OF NORMAN.

2. ALL FILL AREAS INDICATED SHALL BE COMPACTED TO 95% STANDARD PROCTOR DENSITY PRIOR TO CONSTRUCTION IN ACCORDANCE WITH THE CITY OF NORMAN'S "STANDARD SPECIFICATIONS FOR CONSTRUCTION OF PUBLIC IMPROVEMENTS." TEST REPORTS WILL BE SUBMITTED TO THE NORMAN ENGINEER'S OFFICE.

ALL WORK NOT CLASSIFIED AS A "PAY ITEM" SHALL BE CONSIDERED INCIDENTAL CONSTRUCTION, THE COST OF WHICH SHALL BE INCLUDED IN THE COST OF OTHER BID ITEMS.

CONTRACTOR SHALL BE RESPONSIBLE FOR VERIFICATION OF LOCATION OF ALL UTILITIES PRIOR TO EXCAVATION: DAMAGE TO ANY UTILITIES OR STRUCTURE DURING EXCAVATION AND CONSTRUCTION OF PROPOSED WATER MAINS SHALL BE THE RESPONSIBILITY OF THE CONTRACTOR.

TRENCHING SHALL BE BACKFILLED WITH TYPE 'A' AGGREGATE UNDER ALL PAVED AREAS. THE CONTRACTOR SHALL BE PAID FOR THE CALCULATED QUANTITY OF AGGREGATE REQUIRED TO BACKFILL TRENCHES AS ESTABLISHED BY THE CITY OF OKLAHOMA CITY STANDARDS AND SPECIFICATIONS FOR TRENCH WIDTH. IF THE CONTRACTOR OVER CUTS THE TRENCH, THE ADDITIONAL AGGREGATE WILL BE TREATED AS INCIDENTAL CONSTRUCTION AND WILL BE AT THE CONTRACTOR'S EXPENSE

6. THERE SHALL BE A MINIMUM OF 4' OF COVER TO THE TOP OF THE PROPOSED WATER LINE.

WHERE NOT INDICATED, WATER LINES SHALL BE A MINIMUM OF 5' FROM PROPERTY LINES AND EASEMENT LINES AND 4' BEHIND BACK OF CURBS.

ALL FIRE HYDRANTS SHALL BE LOCATED A MINIMUM OF 20' FROM BUILDINGS. 9. ALL DUCTILE IRON PIPE FITTINGS AND GLANDS LOCATED IN CORROSIVE SOIL AS DETERMINED BY THE CITY ENGINEER'S 'CORROSIVE SOIL MAP'

SHALL BE FACTORY APPLIED FUSION BONDED EPOXY COATED (INTERIOR AND EXTERIOR) WHICH MEETS AWWA C-116. THE EPOXY COATING SHALL BE INSTALLED PER THE COATING MANUFACTURERS SPECIFICATIONS. A CERTIFICATE OF COMPLIANCE SHALL BE REQUIRED FROM THE COATING MANUFACTURER STATING THAT THE COATING MEETS ALL REQUIREMENTS MENTIONED HEREIN. HOLIDAY TESTING SHALL BE REQUIRED PER ASTM G 62. THE EPOXY COATING AND THE FACTORY THAT APPLIES THE COATING SHALL BE APPROVED BY THE CITY OF NORMAN. THE FITTING SHALL HAVE NO CEMENT LINING PRIOR TO EPOXY COATING. DUCTILE IRON PIPE NOMINAL WALL THICKNESS SHALL BE 0.34" FOR 12" DIAMETER PIPE, 0.30" FOR 8" DIAMETER PIPE AND 0.28" FOR 6" DIAMETER PIPE.

10. THE CONTRACTOR SHALL SATISFY HIMSELF AS TO THE ACCURACY OF ALL MEASUREMENTS PRIOR TO CONSTRUCTION OF ANY PERMANENT

11. WATER LINE TESTING AND DISINFECTION SHALL BE DONE IN ACCORDANCE WITH OKLAHOMA DEPARTMENT OF ENVIRONMENTAL QUALITY REGULATIONS, OAC 252:626-19-2.

12. THE CONTRACTOR IS RESPONSIBLE FOR THE PROMPT REPLACEMENT AND/OR REPAIR OF ALL TRAFFIC CONTROL DEVICES AND APPURTENANCES DAMAGED OR DISTURBED DUE TO CONSTRUCTION.

13. THE CONTRACTOR SHALL BE RESPONSIBLE FOR THE REPAIR OR REPLACEMENT OF ALL EROSION CONTROL DEVICES DAMAGED DUE TO

14. A COPY OF THE EROSION CONTROL SITE PLAN MUST BE ON SITE AT ALL TIMES AND MADE AVAILABLE TO THE INSPECTOR UPON REQUEST.

15. THE CONTRACTOR MAY BE REQUIRED TO INSTALL ADDITIONAL EROSION CONTROL DEVICES BEFORE FLUSHING WATER LINE TO MINIMIZE EROSION AND TO REMAIN IN COMPLIANCE WITH LOCAL AND FEDERAL NPDES PERMIT REQUIREMENTS.

16. CONSTRUCTION ACTIVITIES THAT RESULT IN LAND DISTURBANCE OF EQUAL TO OR GREATER THAN ONE (1) ACRE, OR LESS THAN ONE (1) ACRE IF THEY ARE PART OF A LARGER COMMON PLAN OF DEVELOPMENT OR SALE THAT TOTALS AT LEAST ONE (1) ACRE MUST ALSO OBTAIN A PERMIT FROM ODEQ (FORM 605-002a) FOR STORM WATER DISCHARGES FROM CONSTRUCTION

ACTIVITIES. THIS MEANS THAT LAND DISTURBING OF ONE (1) ACRE OR MORE MUST PERMIT WITH ODEQ AND THE CITY OF NORMAN, STORM WATER

THE CONTRACTOR SHALL DISPOSE OF WATER FLUSHED FROM THE LINES TO A LOCATION APPROVED BY THE CITY ENGINEER OR DESIGNATED REPRESENTATIVE. IN NO CASE SHALL THE WATER BE FLUSHED INTO THE

18. A WORK ZONE PERMIT MUST BE OBTAINED FROM THE TRAFFIC-MANAGEMENT DIVISION AT LEAST TWO (2) WORKING DAYS PRIOR TO THE START OF WORK AND/OR PLACING OR REMOVING ANY BARRICADES OR MODIFYING EXISTING TRAFFIC CONTROL DEVICES. E-MAIL workzones@okc.gov TO OBTAIN AN APPLICATION.

A MINIMUM PRESSURE OF 25 psi. THE DEVELOPER IS RESPONSIBLE FOR DESIGNING AND CONSTRUCTION OF ALL FIXTURES TO PROVIDE ADEQUATE DOMESTIC AND FIRE PROTECTION UNDER MINIMUM PRESSURE CONDITIONS THE DEVELOPER WILL BE RESPONSIBLE FOR ANY FAILURE OF DOMESTIC AND FIRE PROTECTION SYSTEMS WHICH REQUIRE WATER PRESSURE IN EXCESS OF 25 psi.

20. THE LOCATION OF THE FDC AS SHOWN ON THESE PLANS IS NOT APPROVED AS PART OF THESE PLANS. LOCATION OF THE FDC MUST BE COORDINATED THROUGH & APPROVED BY THE FIRE MARSHALL

21. ALL PROPOSED WATER METERS AND FIRE HYDRANTS TO BE LOCATED OUTSIDE OF THE PROPOSED SIDEWALK.

22. CONTRACTOR SHALL INCLUDE ALL COSTS FOR METER AND INSTALLATION IN BID. INSPECTION FEES WILL BE WAIVED. PERMIT SHALL BE REQUIRED.

### POLYVINYL CHLORIDE PIPE (PVC) INSTALLATION NOTES

- PIPE PVC PRESSURE PIPE SHALL BE AWWA C,900, PRESSURE CLASS 200 AND WITH A MINIMUM DIMENSION RATIO OF EIGHTEEN (DR-18).
- FITTINGS FITTINGS SHALL BE MECHANICAL JOINT TYPE AS SPECIFIED UNDER DUCTILE IRON FITTINGS. ALL FITTINGS SHALL HAVE POLYETHYLENE ENCASEMENT TUBING WITH A THICKNESS OF 8 MIL. SEE WATER - GENERAL NOTE 9
- TRACER WIRE (ONE #12 SHALL BE PLACED ON TOP OF PVC PIPE), A WEATHER HEAD AND 5F GALVANIC ANODE'S SPACED AT 500 FT INTERVALS SHALL BE PROVIDED AS SHOWN ON CITY OF NORMAN STANDARD NO. W11. SEE DETAIL SHT. WF5.
- JOINT RESTRAINTS - THE JOINTS SHALL BE RESTRAINED USING CONCRETE THRUST BLOCK AND MECHANICAL JOINT RESTRAINT FOR AWWA C-900. JOINT RESTRAINTS SHALL BE MANUFACTURED BY EBBA IRON SALES, INC., OR UNI-FLANGE BY THE FORD METER BOX CO., INC., OR APPROVED EQUAL.
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- 6. PIPE BEDDING SEE DETAIL SHT. WF5


#### **BILLING ADDRESS**

CITY OF NORMAN 201A W. GRAY ST. NORMAN, OK 73069

#### **BUILDING ADDRESS:**

CITY OF NORMAN 201A W. GRAY ST. NORMAN, OK 73069

## The City of NORMAN

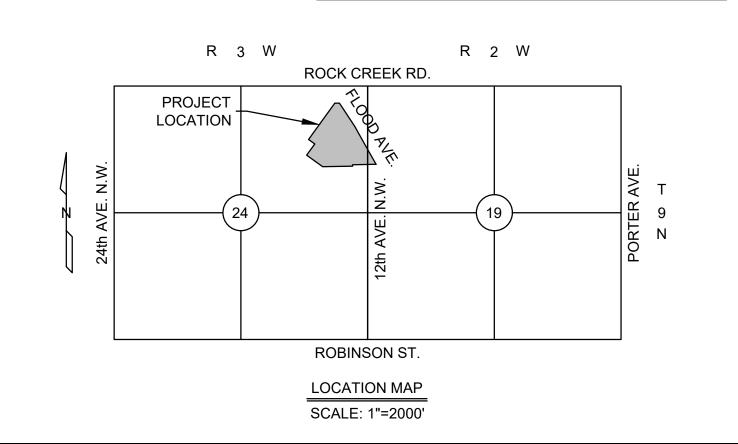



#### SHEET INDEX

## SHEET No. DESCRIPTION WF1 TITLE SHEET, QUANTITIES WF2 PUBLIC WATER LINE GENERAL LAYOUT

#### ONE CALL UTILITY LOCATION NUMBER

840-5032 1-800-522-6543 This number is to be used for information on the location of all underground utilities. Contact this number and other numbers specified in the plans prior to any excavation.

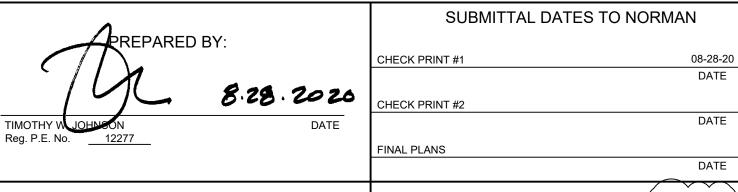

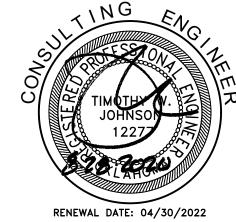

OR THAT APPROVAL IS WITHDRAWN. DEPARTMENT OF PUBLIC WORKS

**ENGINEERING DIVISION** 

CONSTRUCTION MUST BEGIN WITHIN TWO (2)


YEAR FROM THE DATE OF APPROVAL,


Field Checked by: Date: Checked by: Date: Checked by: Date: Johnson & Associates, Inc. Date: Checked by: 1 E. Sheridan Ave., Suite 200


Oklahoma City, OK 73104 (405) 235-8075 FAX (405) 235-8078 www.jaokc.com Certificate of Authorization #1484 Exp. Date: 06-30-2021


City Engineer

Date:

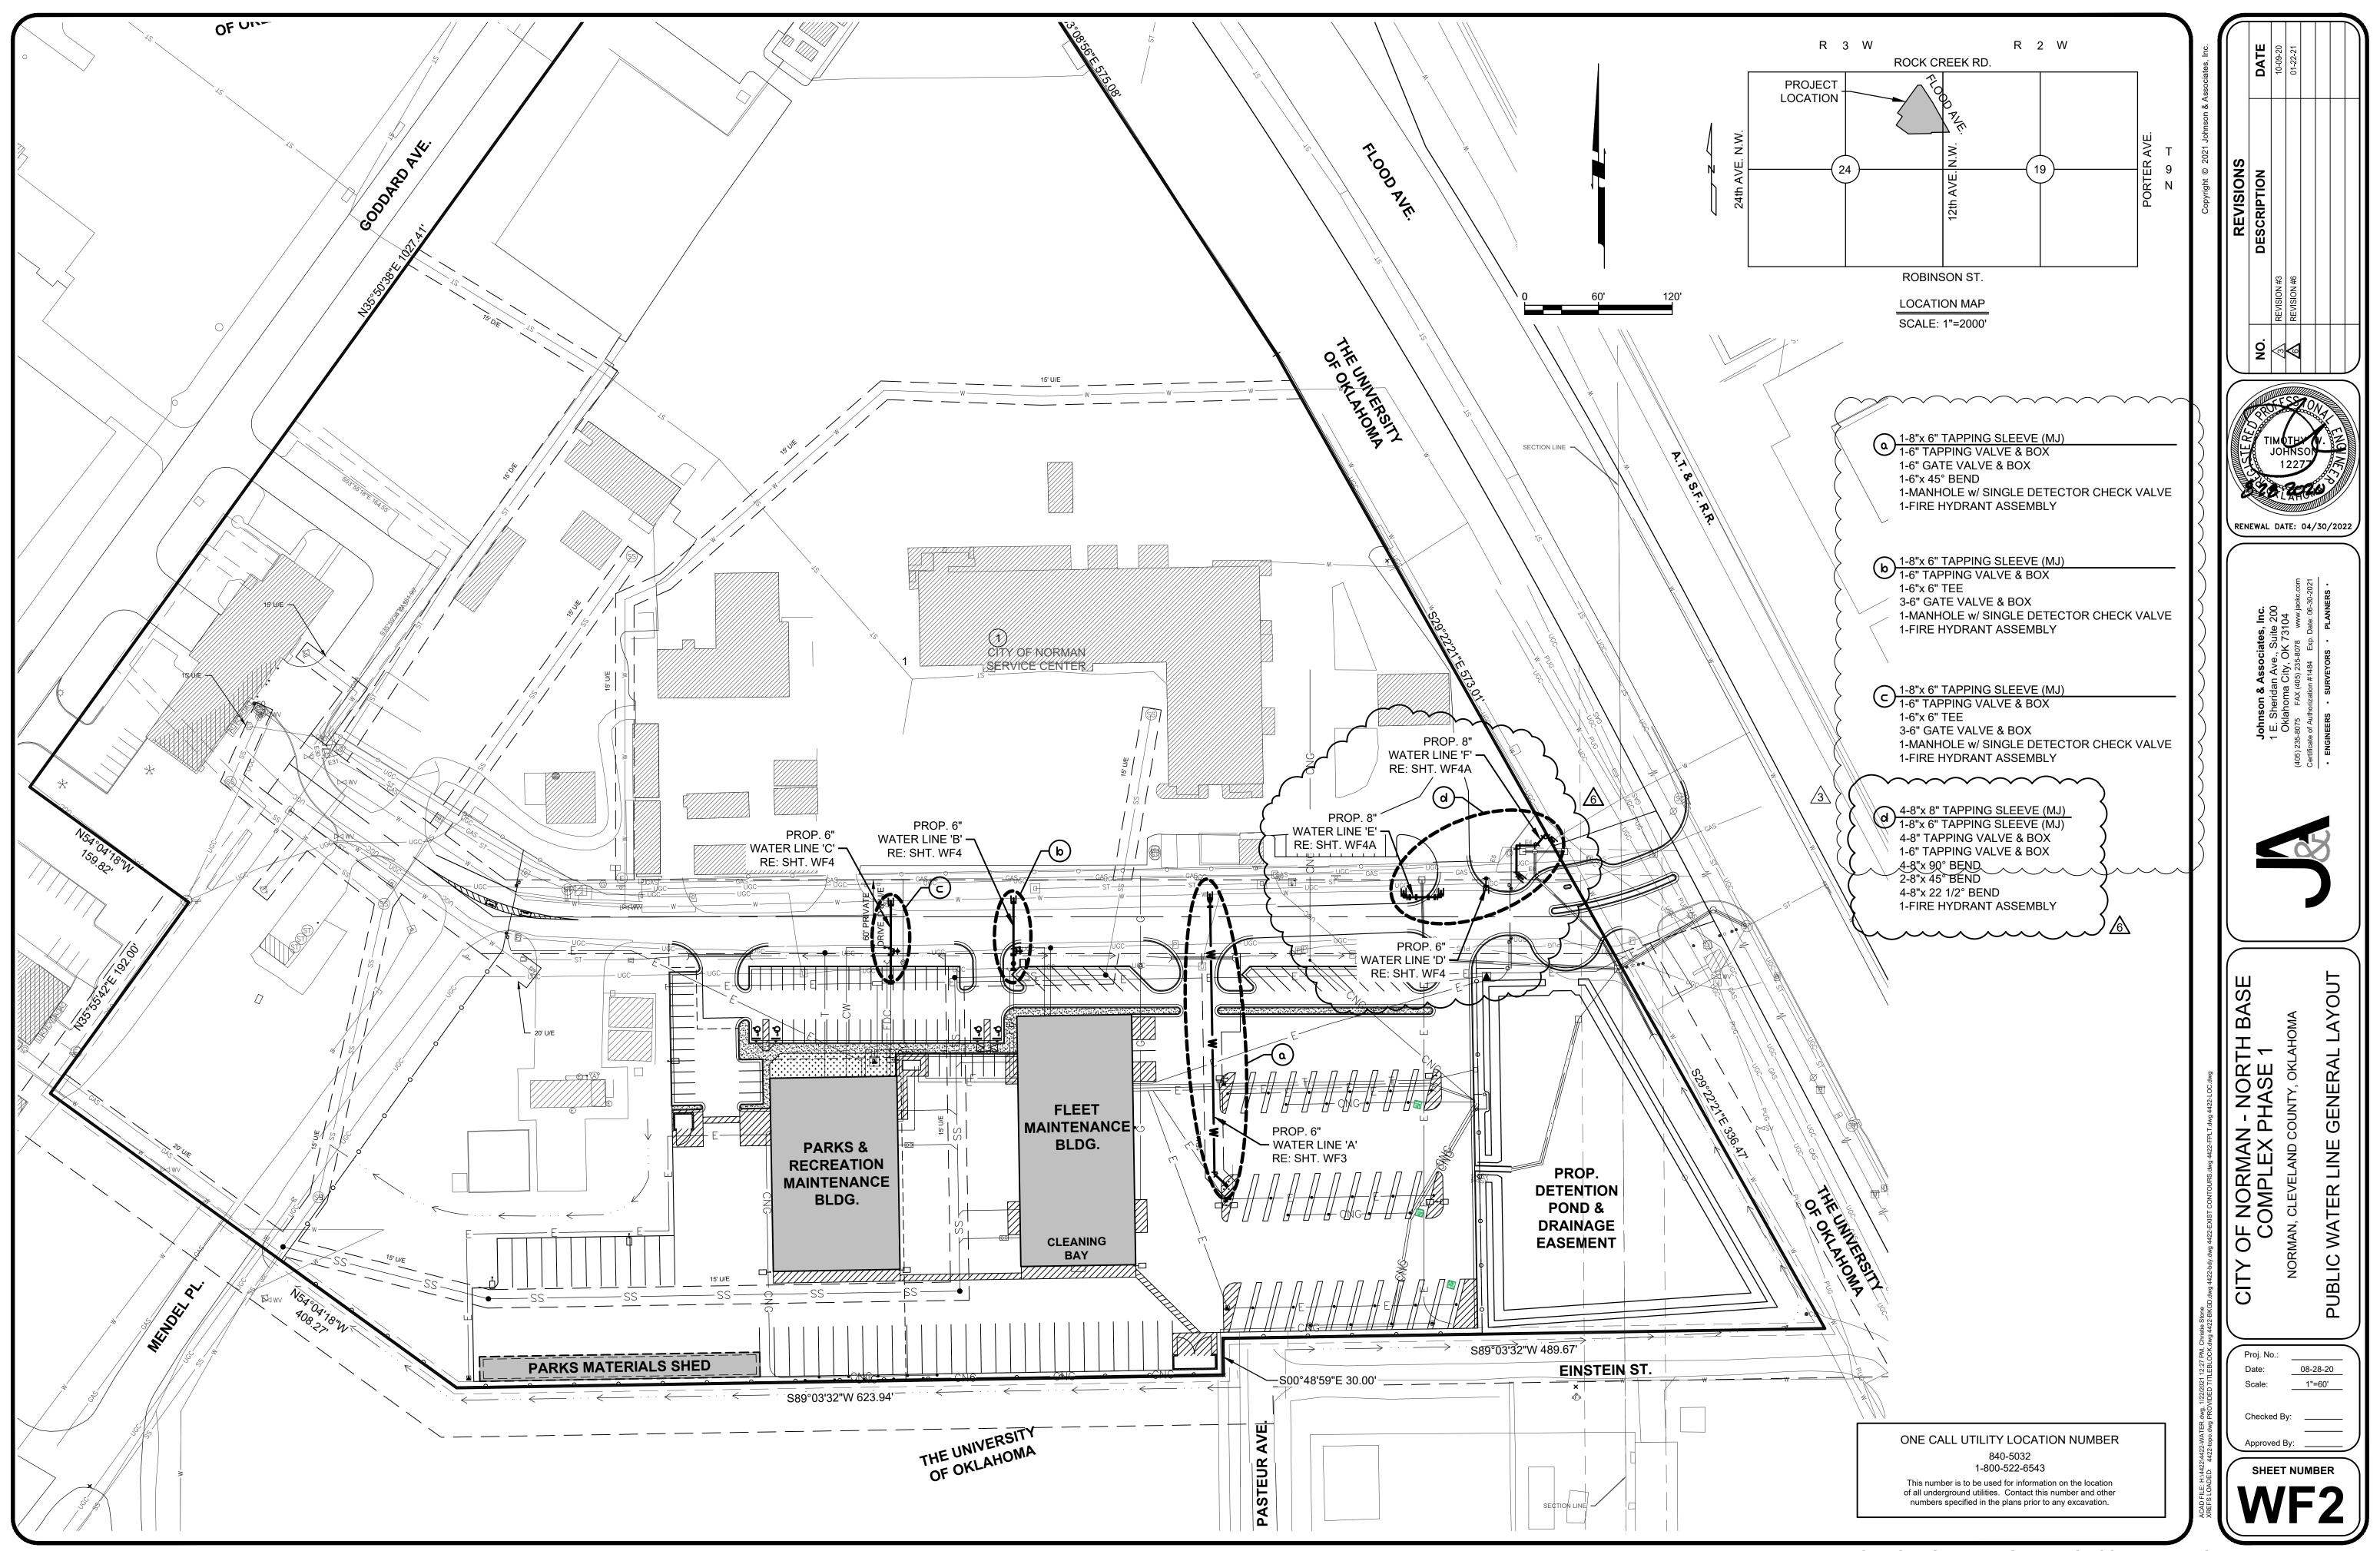

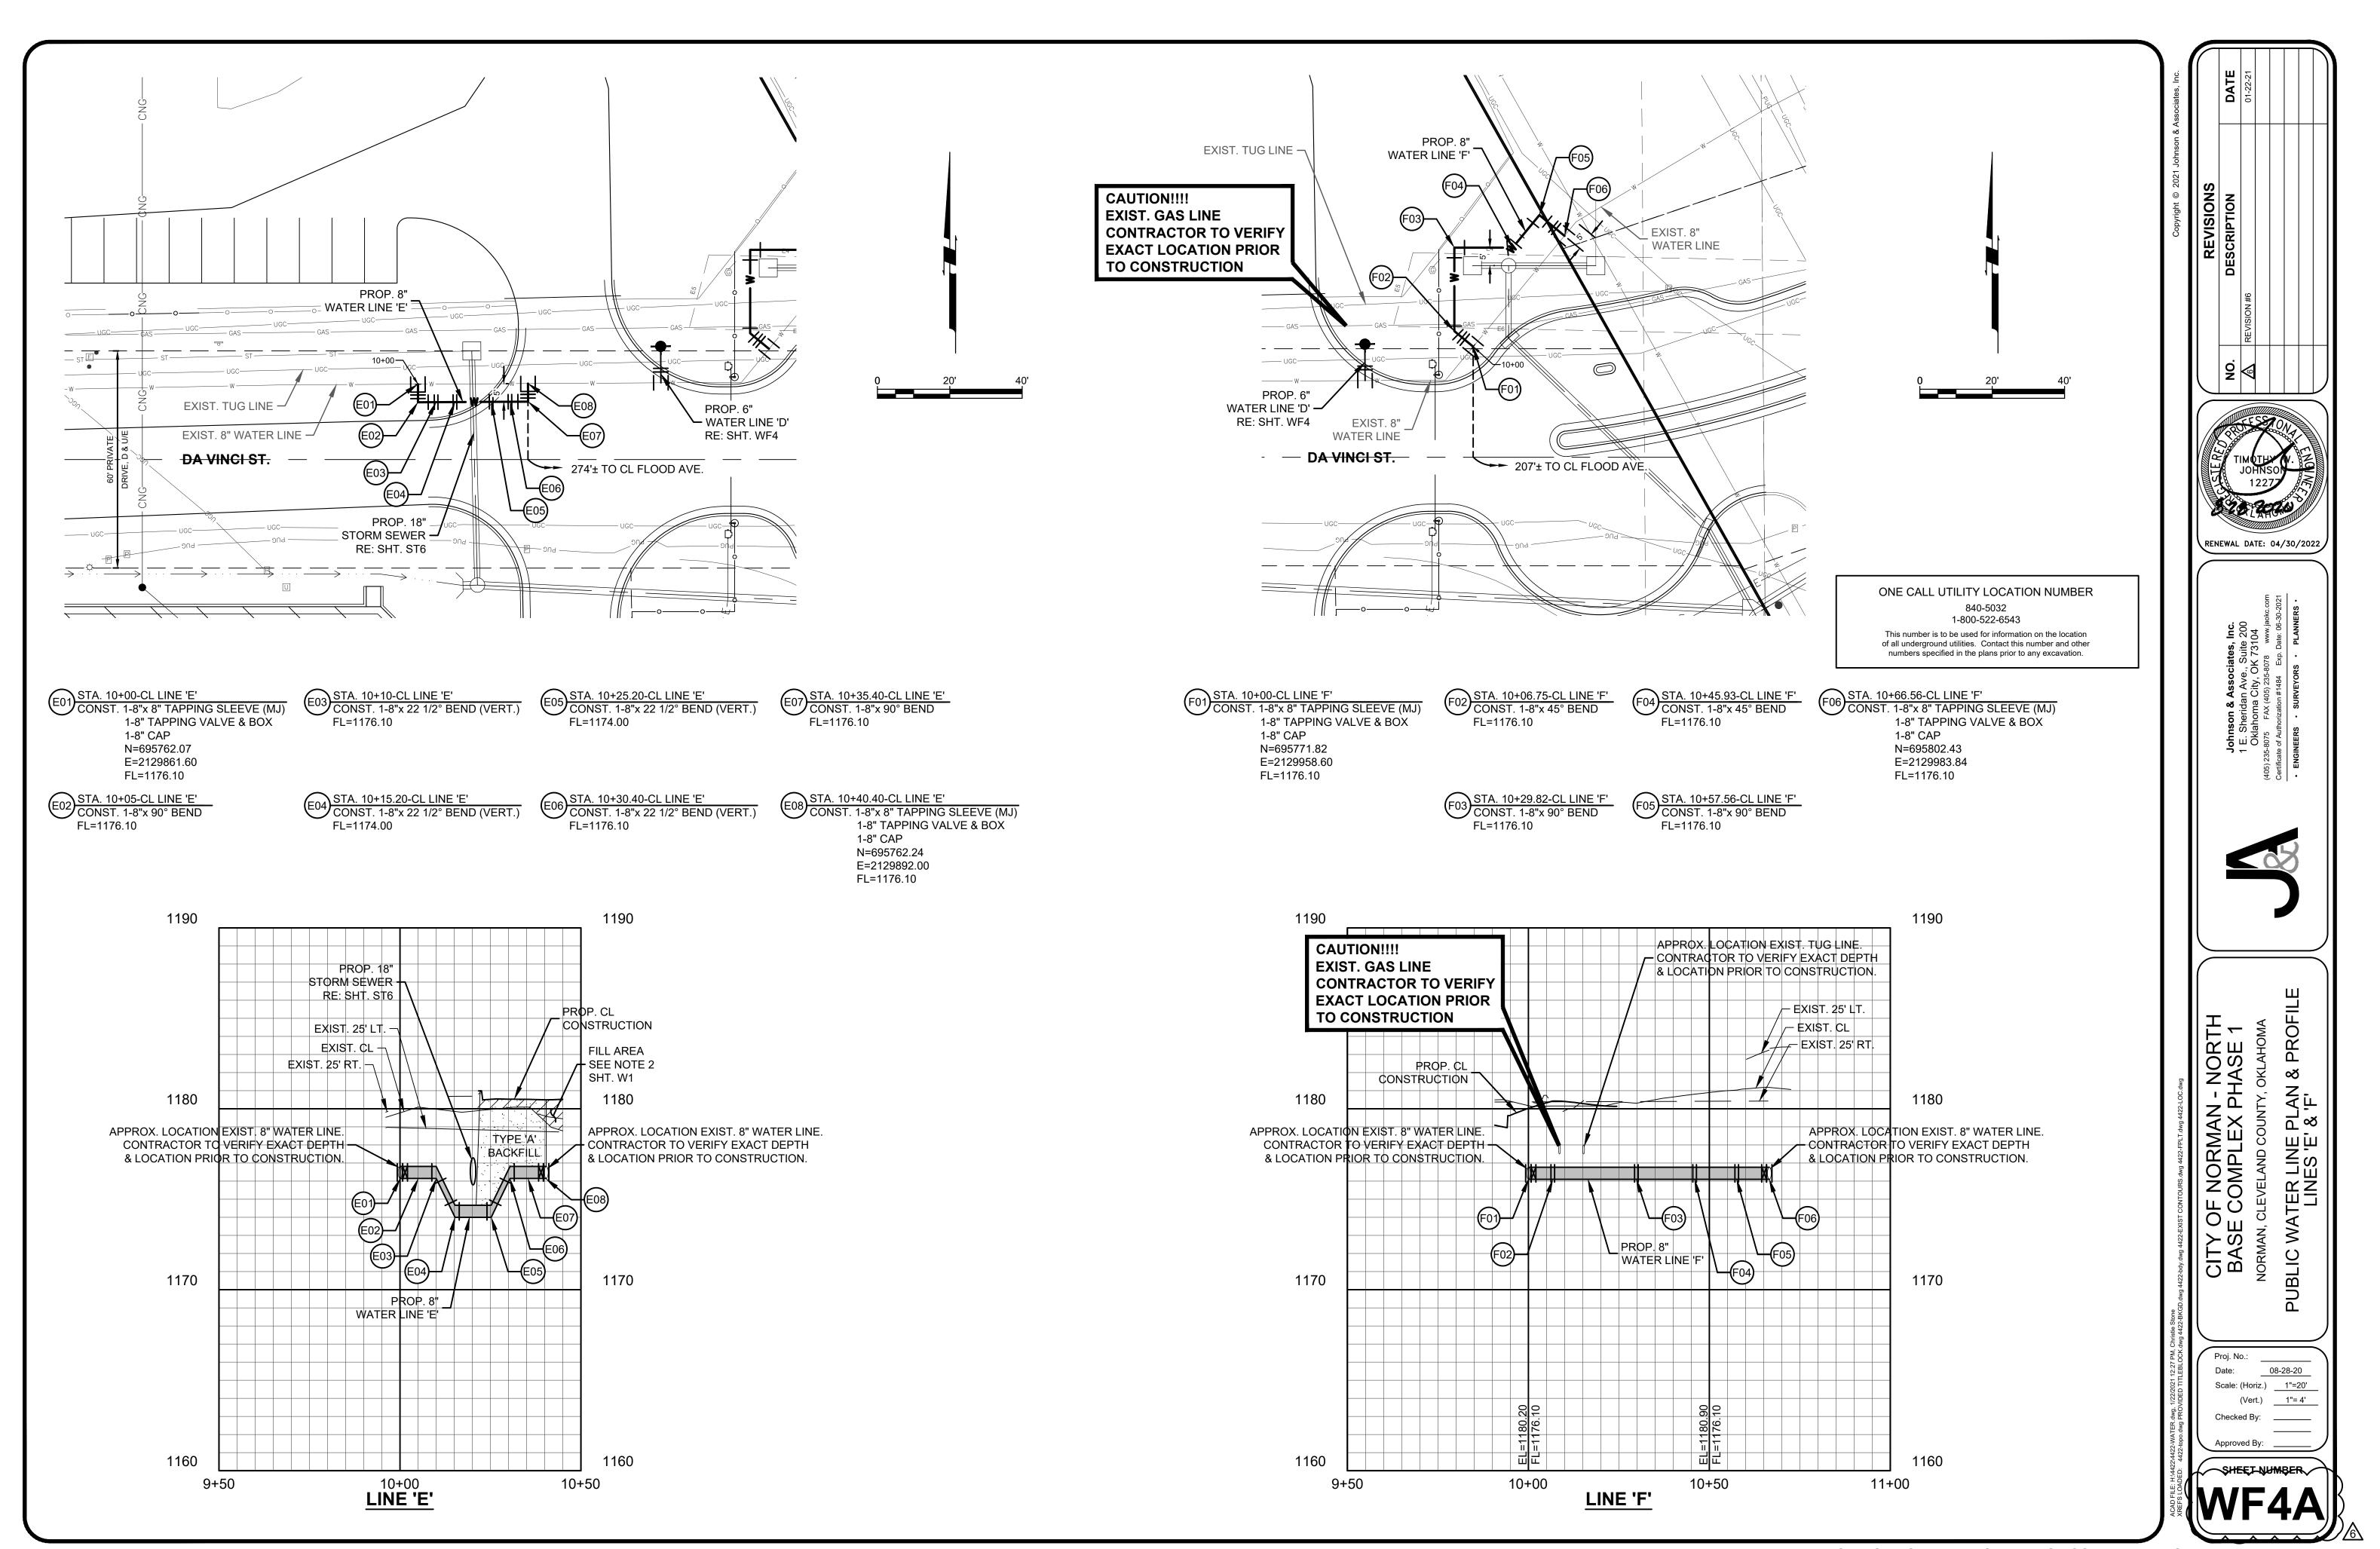

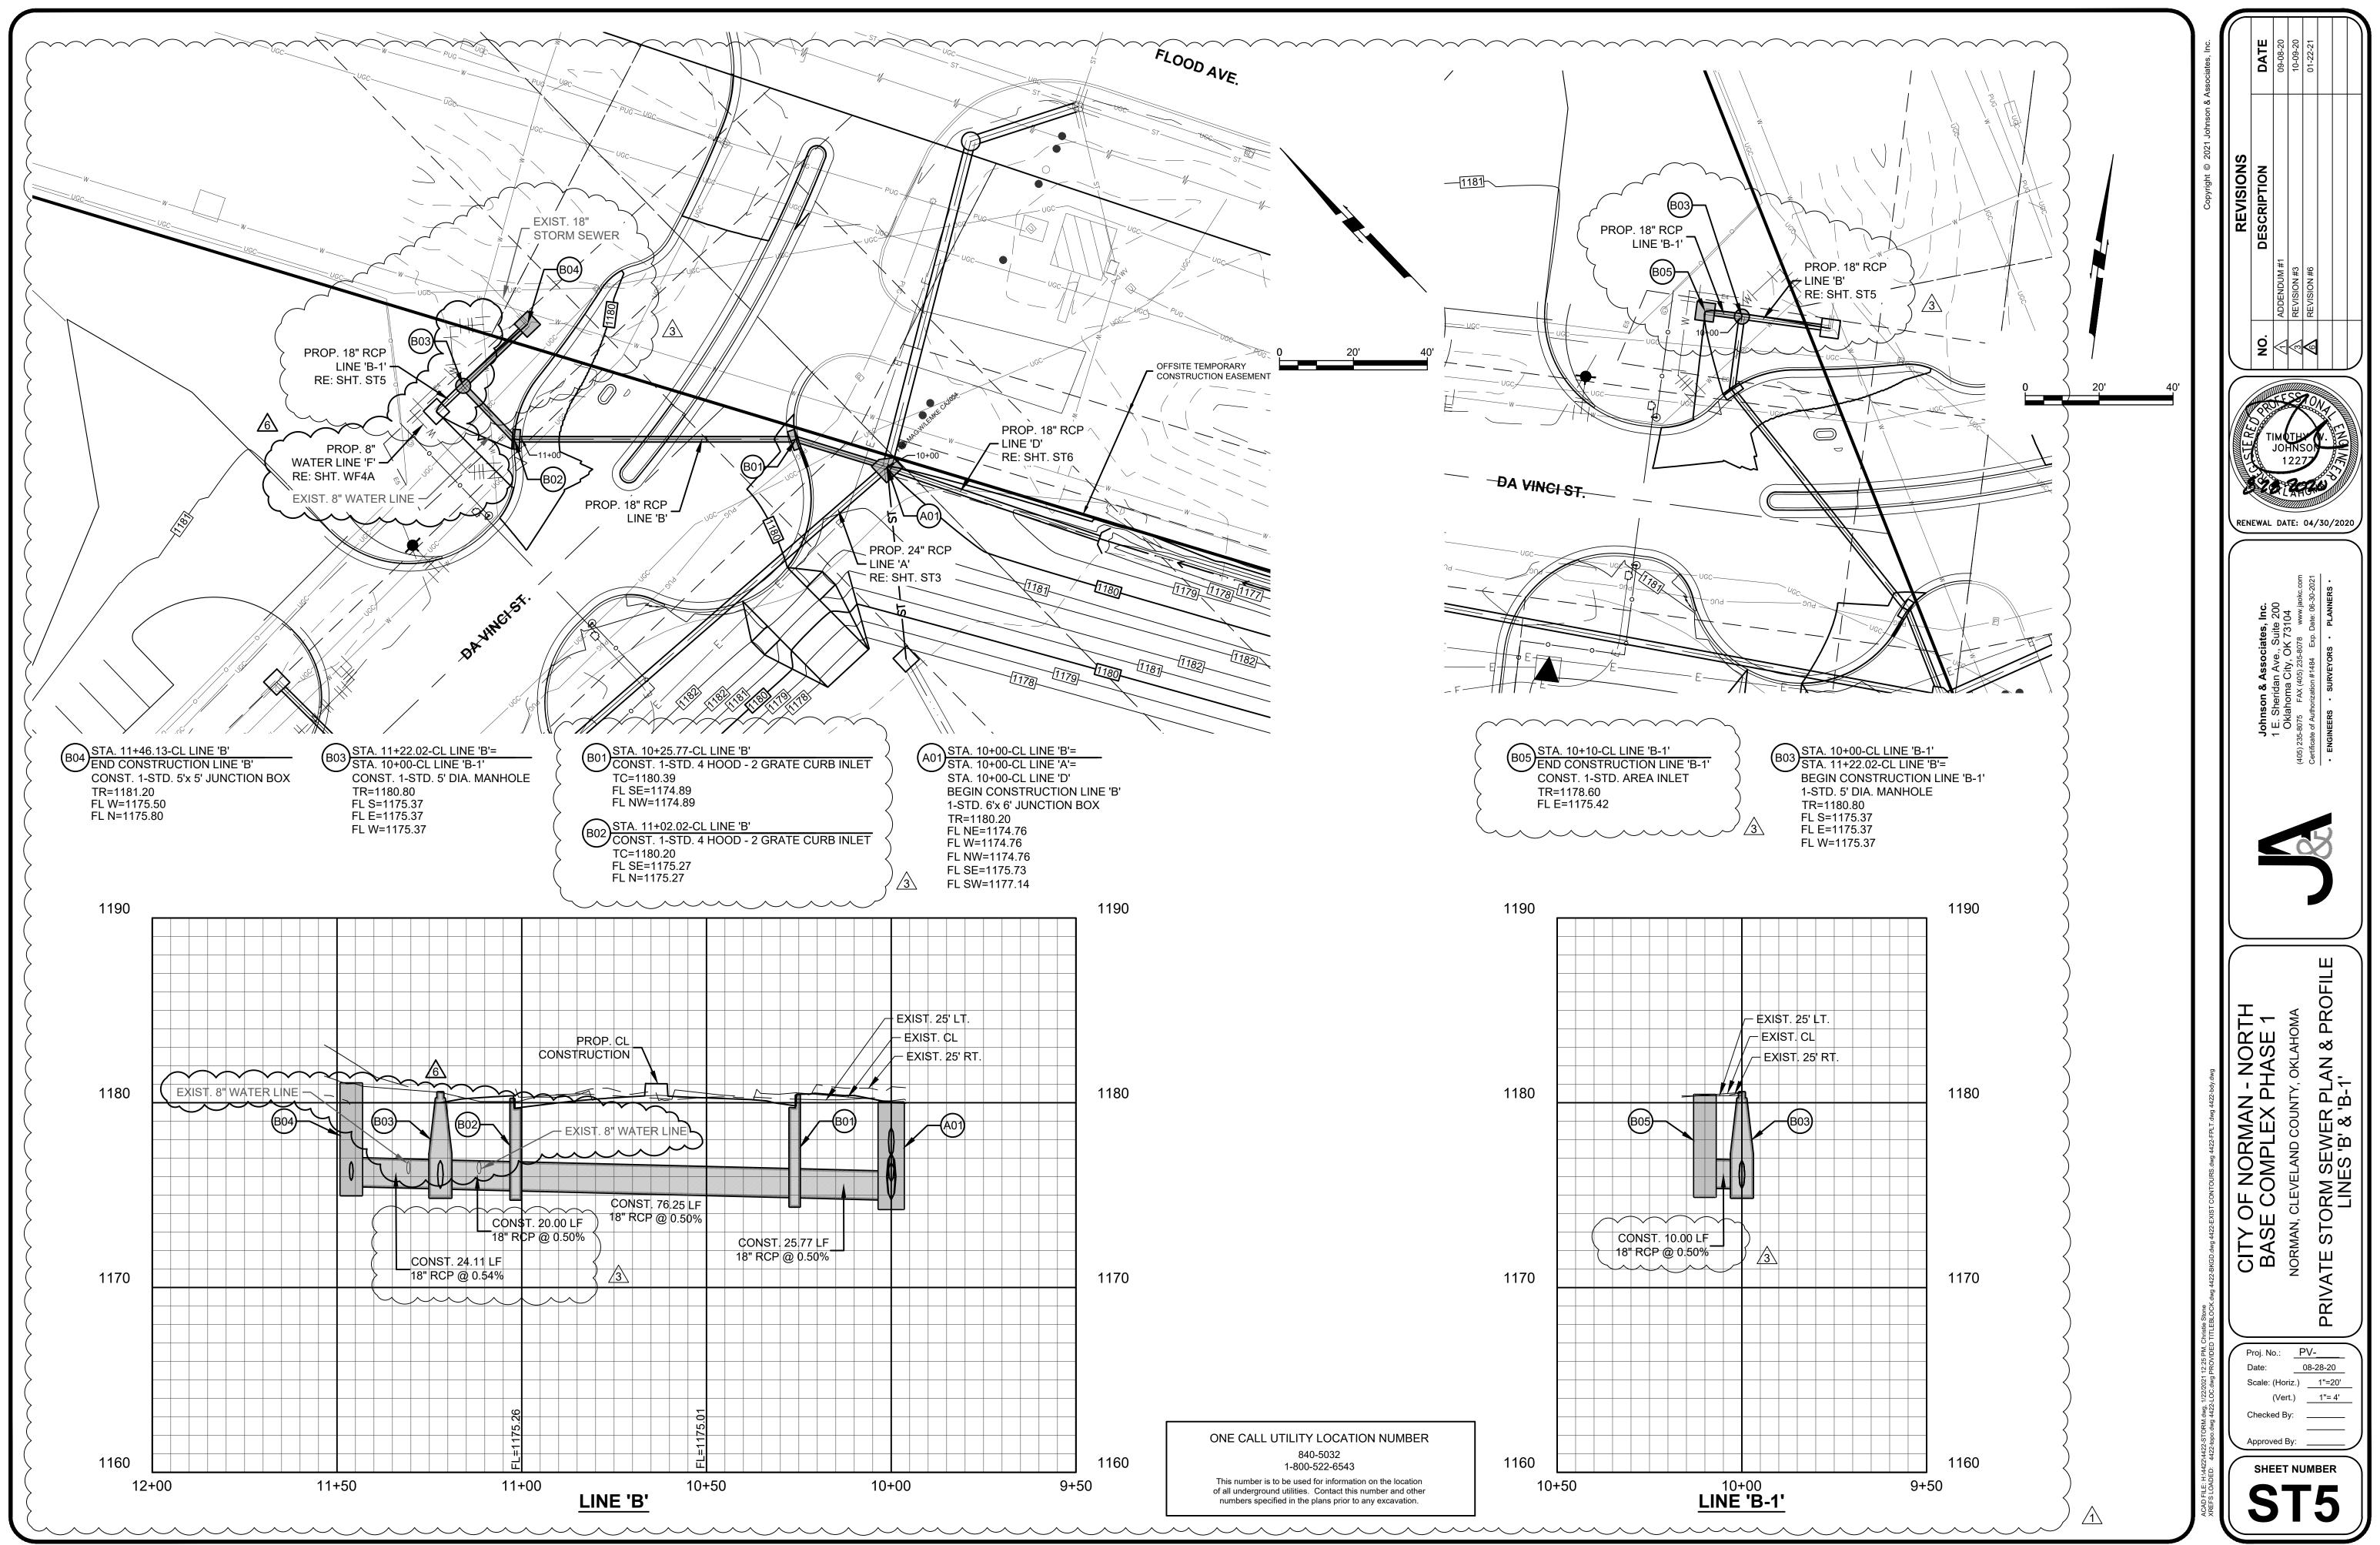

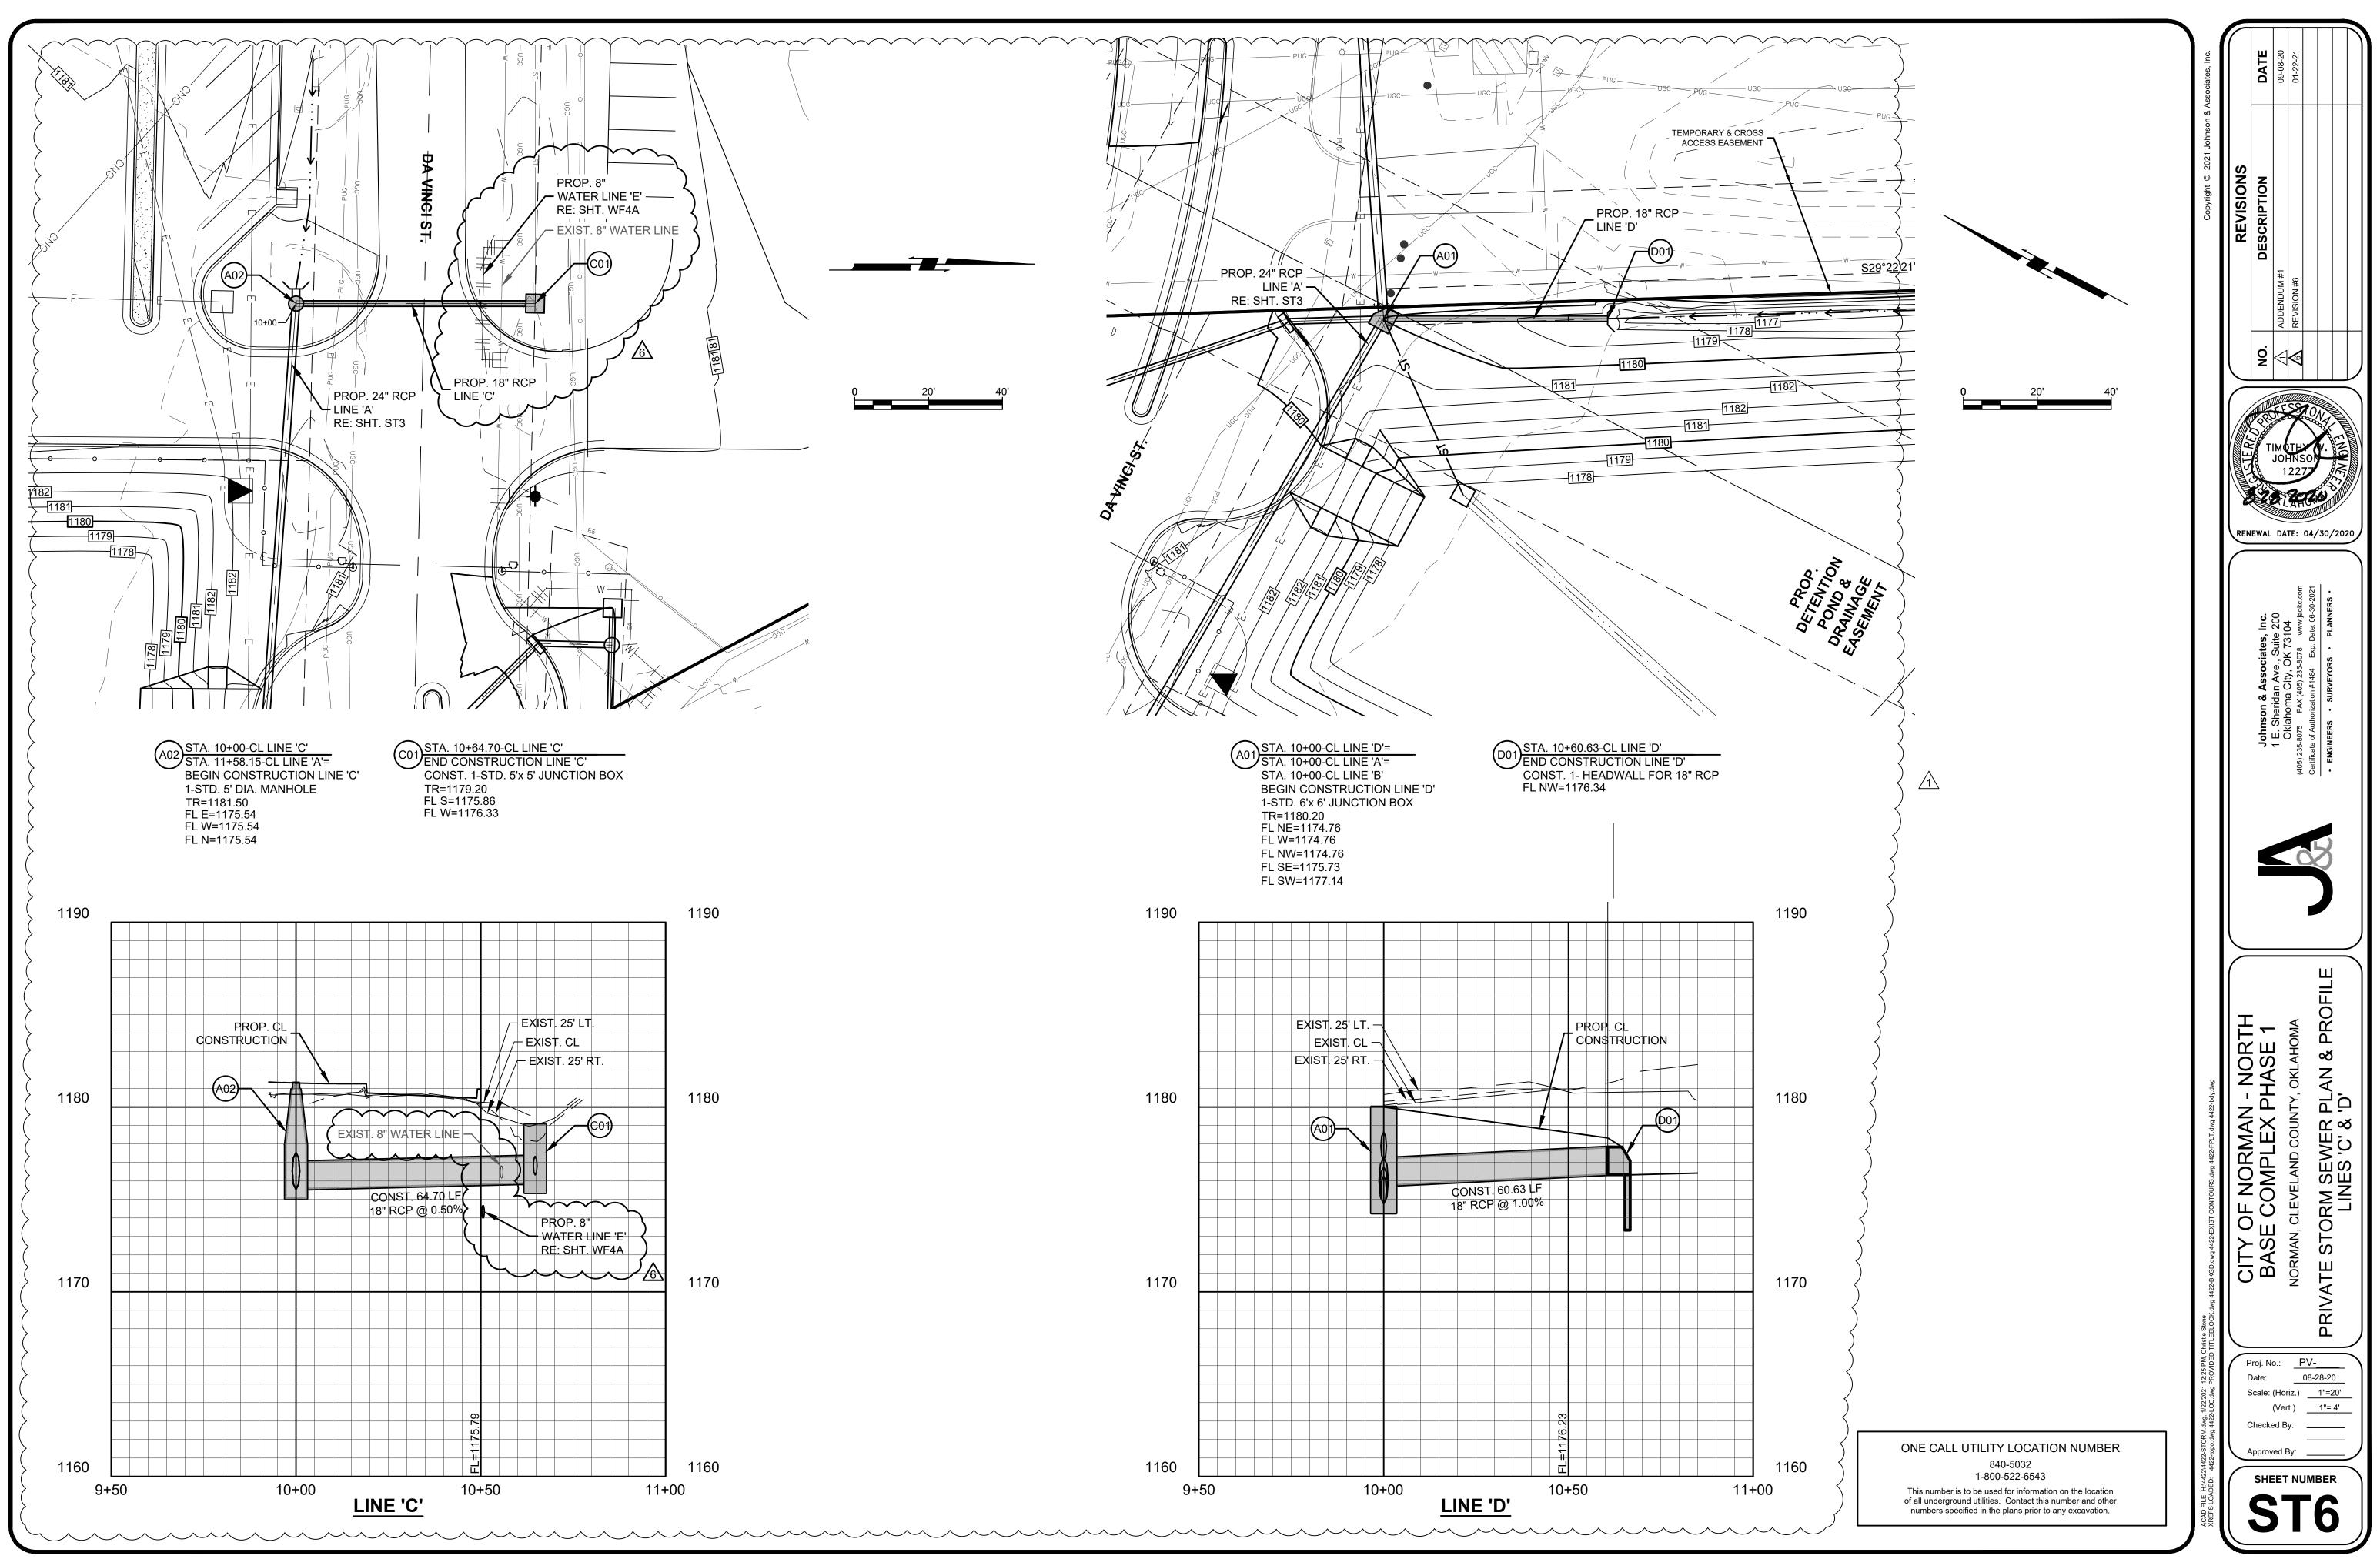

## RFI #20 REMOVAL OF EXISTING UNFORSEN PIPE

#### PROPOSED CHANGE ORDER SUMMARY

SUBCONTRACTOR WORK or

X CONSTRUCTION MANAGER SELF PERFORMED WORK

Subcontractor	Name	(if ap	plicable)
---------------	------	--------	-----------

Oakridge Builders a Division of Flintco, LLC

#### THE CITY OF NORMAN

 Project Name/#:
 Norman North Base - Phase 1 20136 (Main Job)

 CE No:
 #002

 CE Title:
 RFI #20 Removal of Existing Unforseen Pipe

 CE Date:
 2/4/2021

<u>PCOR</u>			<u>Labor</u>		<u>Equipment</u>			Subcontract	
Item No	Description	Hours	Costs		Type	Cost		Cost	
1	Direct Labor	24 (@\$45hr)	\$ 1,080.0	0	•		\$	1,080.00	
	Direct Subcontracts (Pipe	, , , ,			Dumpster				
2	Removal)				Pulls/Excavator	\$ 1,150.00	\$	1,150.00	
3	Supervision/Safety		\$ 300.0	0			\$	300.00	
4	Expendable Small Tools				Expendable Tools	\$ 100.00	\$	100.00	
Subtotals			\$ 1,380.0	0 \$ -		\$ 1,250.00	\$	2,630.00	
Labor Bu	urden (@ 58%)	1	\$ 800.	0					
Total Ra	w Costs		\$ 3,430.4	0					
Overhea	d *		\$ 257.3		d + Profit limited to ≤ 15% of	of			
Profit *		\$ 257.3	8 Total Raw Costs	s (by contract)					
	Subcontractor's Insurance (applies to subcontractor work only)		\$ -	← do not include a	n amount here if CM Self F	erformed Work			
Subcontractor's Bonds (applies to subcontractor work only)		\$ -	← do not include a	n amount here if CM Self F	erformed Work				
				150 1					
					vork, enter total in Section 1 Change Order Summary fo				
Total for S	ubcontractor or CM Self-Perfor	med Work	\$ 3,944.5	6 If CM Self-Perform	med work, enter total in Se	ction 3			
				of CM Proposed	Change Order Summary F	orm.			
			l .						



Flintco LLC (40-000) 2302 South Prospect Oklahoma City , Oklahoma 73129 Phone: (405) 670-6307 Project: 20136 - City of Norman - North Base Complex Phase 1 1310-1380 DA Vinci Street Norman, Oklahoma 73069

Unknow Underground Lines					
то:	Michael Segroves GSB, Inc. 3555 NW 58th Street, Suite 700W Oklahoma City, Oklahoma 73112	FROM:	Zack Blair Flintco, LLC - OKC 2302 S. Prospect Oklahoma City, Oklahoma 73129		
DATE INITIATED:	01/22/2021	STATUS:	Open		
REFERENCE:		DUE DATE:	02/02/2021		
COST IMPACT:	Yes (Unknown)	SCHEDULE IMPACT:	Yes (Unknown)		
LINKED DRAWINGS	:	RECEIVED FROM:			

#### **COPIES TO:**

Carolyn Bennett (GSB, Inc.), Paul D'Andrea (City of Norman), Geoff Evans (Planning Design Group), Phillip Gunderson (Flintco, LLC - OKC), Bill Harrell (ADG), Sarah Hendrickson (ADG), Randy Hill (ADG), Cory Rackley (Flintco, LLC - OKC), Jason A. Spencer (City of Norman), David Stapp (Flintco, LLC - OKC), Ethan Treisa (Flintco, LLC - OKC)

#### Question from Zack Blair (Flintco, LLC - OKC) at 04:36 PM on 01/22/2021

Reference attached sketch with photo.

While excavating to subgrade on the south end of the east parking lot on 1/22/2021, two unknown underground lines were uncovered. One of the lines is coated poly, and the other line is steel, but both lines are 3". After researching with Norman Utilities Division and ONG, it was determined that the owner/purpose of these lines is unknown. Both lines are above dirt subgrade for this parking lot and will need to be demoed. Once known, please advise of the plan to demo these lines, and advise if this work will need to be performed by Flintco.

#### Attachments:

RFI 020 - SK1.pdf

#### Official Response

Awaiting an Official Response


#### All Replies: RESPONSE 2021 01 26:

REFER TO THE ATTACHED AERIAL PHOTOGRAPHY DATED 1951 & 1963 RESPECTIVELY. BASED ON THIS, THE LINES WOULD APPEAR TO HAVE SERVED STRUCTURES THAT HAVE BEEN PREVIOUSLY DEMOLISHED.

SINCE THE CONTRACTOR HAS DETERMINED THAT THESE LINES ARE NOT OWNED BY THE CITY OF NORMAN, FLINTCO SHALL CONTACT OKIE TO DETERMINE IF THERE ARE ANY EXISTING ATLASES THAT MAY CONTAIN OWNERSHIP INFORMATION ON THE LINES. IF NONE CAN BE DTERMINED, THE CONTRACTOR SHALL OBTAIN A COST PROPOSAL FROM A QUALIFIED UTILITY LOCATION COMPANY TO DETERMINE THE EXTENT OF THE LINES AND/OR IF THEY ARE ABANDONED OR CONNECTED INTO ANY EXISTING ACTIVE UTILITIES THAT MAY INDICATE OWNERSHIP OR TYPE. IF NONE CAN BE DETERMINED, THE CONTACTOR OR THEIR DESIGNATED & QUALIFIED UTILITY LOCATOR SHALL TAP THE LINES TO DETERMINE TYPE AND ACTIVE STATUS.

MICHAEL SEGROVES, AIA / AICP

PROJECT ARCHITECT - GSB ARCHITECTS

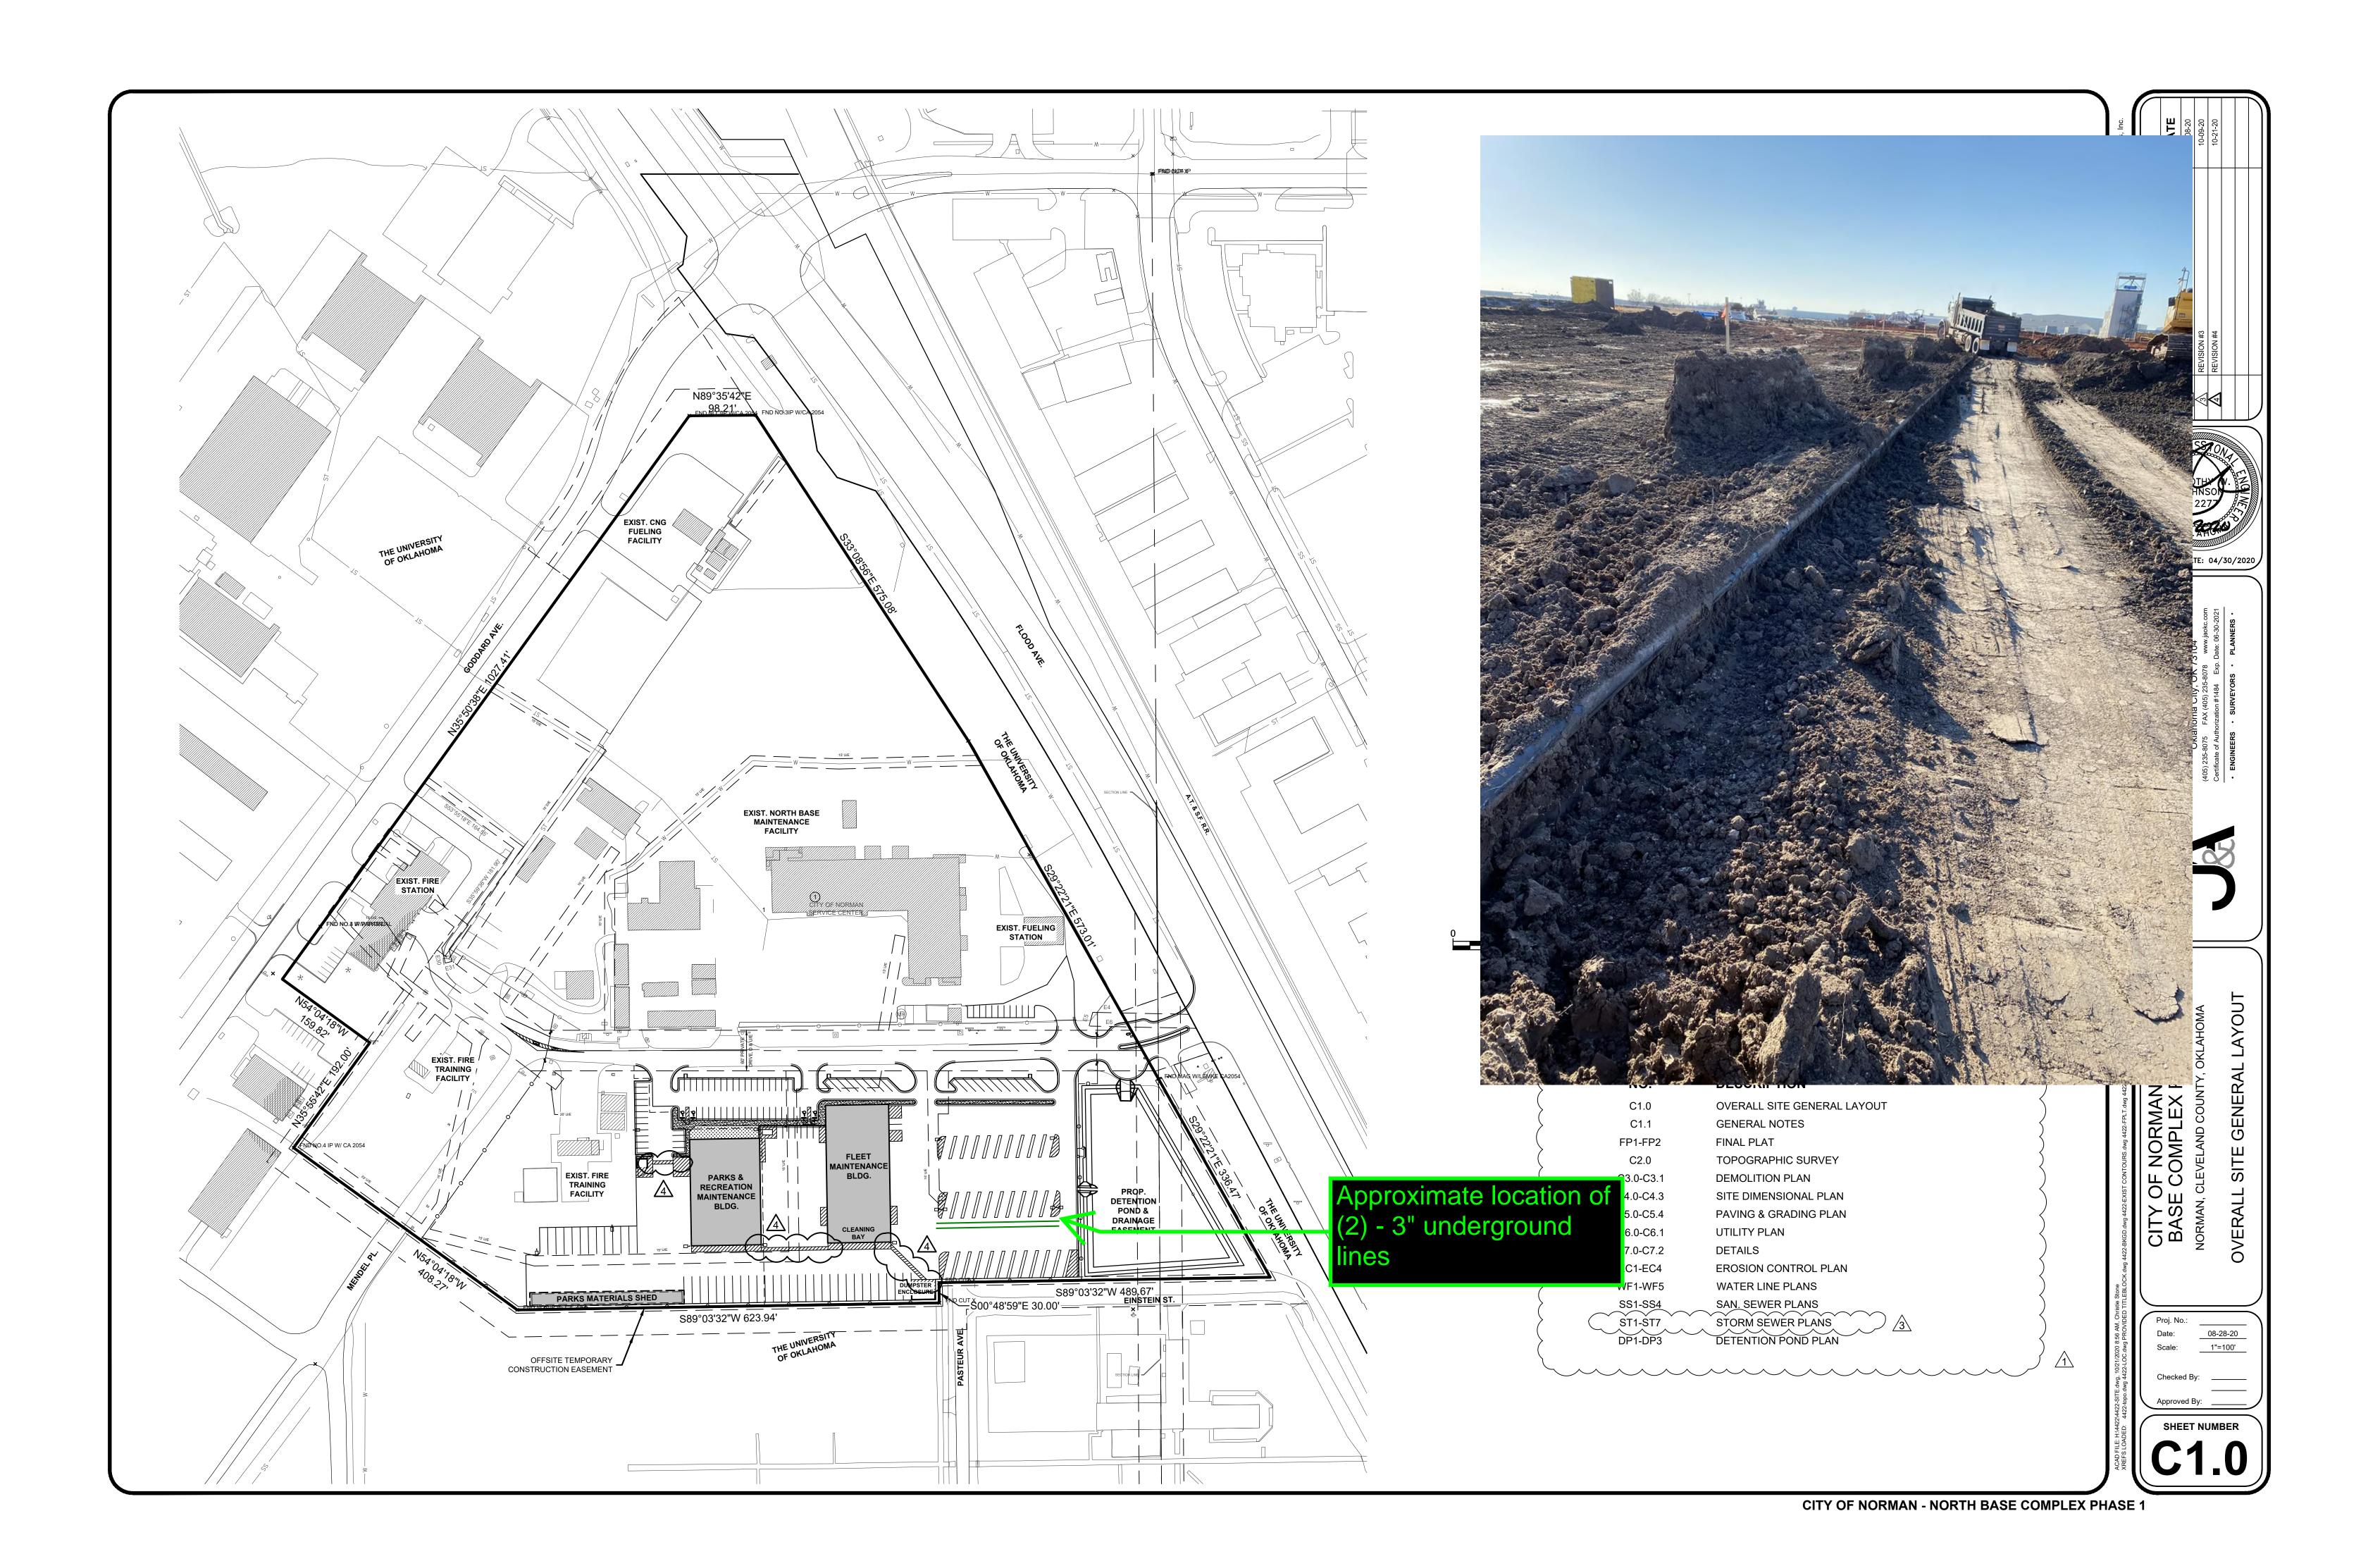

OWNER
CITY OF NORMAN, OKLAHOMA
201 A WEST GRAY STREET NORMAN, OKLAHOMA 73069 (405) 366-5406 www.NormanOK.gov

ARCHITECT GSB, INC 3555 NW 58th Street, Suite 700W

Oklahoma City, OK 73112 (405) 848-9549 www/gsb-inc.com CIVIL ENGINEER

JOHNSON & ASSOCIATES 1 EAST SHERIDAN AVE.- STE. 200 OKLAHOMA CITY, OKLAHOMA 73104 (405) 235-8075 www.jaokc.com

STRUCTURAL ENGINEER WALLACE ENGINEERING 410 NORTH WALNUT AVE. - STE. 200 OKLAHOMA CITY, OK 73104 (405) 236-5858 www.wallacesc.com

M/ P/ FP ENGINEER ALLEN CONSULTING, INC. 110 NORTH MERCEDES DRIVE NORMAN, OK 73069 (405) 928-7702


www.acimep.com ELECTRICAL ENGINEER 1306 COMMERCE DRIVE

HORNER ASSOCIATES ENGINEERS NORMAN, OKLAHOMA 73071 (405) 801-2528 www.haeinc.com

LANDSCAPE ARCHITECT PLANNING DESIGN GROUP 5314 SOUTH YALE AVE - STE. 510 TULSA, OKLAHOMA 74135 (918) 628-1255

www.planningdesigngroup.com

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**REVISIONS** 

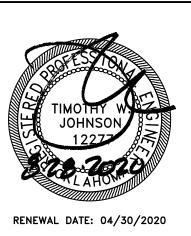NO. DATE DESCRIPTION

GSB PROJECT NO.

DRAWING TITLE OVERALL SITE GENERAL LAYOUT

08-28-20

DRAWING NO.

C1.0

## RFI #17 ADDITIONAL FOUNDATIONS AT FLEET BUILDING

#### PROPOSED CHANGE ORDER SUMMARY

SUBCONTRACTOR WORK or

X CONSTRUCTION MANAGER SELF PERFORMED WORK

Subcontractor Name (if applicable):

Oakridge Builders a Division of Flintco, LLC/4G Concrete, Inc.

#### THE CITY OF NORMAN

 Project Name/#:
 Norman North Base - Phase 1 20136 (Main Job)

 CE No:
 #002

 CE Title:
 RFI #17 Additional Foundations at Fleet Building

 CE Date:
 2/4/2021

PCOR			<u>Labor</u>		<u>Material</u>		<u>Equipment</u>			Subcontract	
Item No	Description	Hours	Costs	1			Type		Cost		Cost
	Direct Labor	36 (@\$45hr)	\$	1,620.00						\$	1,620.00
2	Direct Materials (Rebar & Concrete)				\$	5,785.00				\$	5,785.00
	Direct Subcontracts (Spoils Removal)						Dump Truck	\$	1,200.00	\$	1,200.00
4	Supervision/Safety		\$	164.00			•			\$	164.00
	Expendable Small Tools						Expendable Tools	\$	171.00	\$	171.00
											-
Subtotals			\$	1,784.00	\$	5,785.00		\$	1,371.00	\$	8,940.00
Labor Bu	irden (@ 58%)	_	\$	1,034.72							
Total Rav	w Costs		\$	9,974.72							
Overhead *		_	\$	748.10	* Sum of Overhead + Profit limited to ≤ 15% of						
Profit *		\$	748.10		tal Raw Costs (						
Subcontr	Subcontractor's Insurance (applies to subcontractor work only)		\$		← do not include an amount here if CM Self Performed Work						
	Subcontractor's Bonds (applies to subcontractor work only)		\$	-	1		amount here if CM Self P				
					· If Sı	ubcontractor wo	ork, enter total in Section 1				
Total for <u>Su</u>	ubcontractor or CM Self-Perfor	med Work	\$	11,470.93	of 0	CM Proposed C M Self-Perform	change Order Summary fo ed work, enter total in Sec Change Order Summary Fo	tion 3			



Flintco LLC (40-000) 2302 South Prospect Oklahoma City , Oklahoma 73129 Phone: (405) 670-6307



Project: 20136 - City of Norman - North Base Complex Phase 1 1310-1380 DA Vinci Street Norman, Oklahoma 73069

Interior Column Discrepancies Fleet Maintanence					
TO:	Michael Segroves GSB, Inc. 3555 NW 58th Street, Suite 700W Oklahoma City, Oklahoma 73112	FROM:	Phillip Gunderson Flintco, LLC - OKC 2302 S. Prospect Oklahoma City , Oklahoma 73129		
DATE INITIATED:	01/05/2021	STATUS:	Open		
REFERENCE:		DUE DATE:	01/14/2021		
COST IMPACT:	TBD	SCHEDULE IMPACT:	No		
LINKED DRAWINGS	S:	RECEIVED FROM:	David Stapp (Flintco, LLC - OKC)		

#### **COPIES TO:**

Carolyn Bennett (GSB, Inc.), Zack Blair (Flintco, LLC - OKC), Paul D'Andrea (City of Norman), Geoff Evans (Planning Design Group), Randy Hill (ADG), Cory Rackley (Flintco, LLC - OKC), David Stanton (GSB, Inc.), David Stapp (Flintco, LLC - OKC), Ethan Treisa (Flintco, LLC - OKC), Steve Tresemer (GSB, Inc.)

#### Question from Phillip Gunderson (Flintco, LLC - OKC) at 12:11 PM on 01/05/2021

See the attached excerpt from the Approved as Noted Nucor PEMB Drawings for the Fleet Maintenance Building.

Upon review, Flintco noticed the following discrepancies from the current Structural Drawings issued with Revision 5.

See noted discrepancies below and requested confirmation:

- 1. Per the Structural Drawings no foundations are currently show under the six (6) interior columns (J) for the bridge crane. Please confirm if foundations are required. Also, please confirm/provide an embed and/or foundation detail for the anchor bolts in these locations.
- 2. Two (2) interior columns (AA) are currently shown on Nucor's PEMB Drawings; however, are not shown on the current Structural Drawings. Please confirm the addition/location of these columns is acceptable. If so, please provide the foundation details required at these column locations.
- 3. One (1) interior column (AA) is currently shown on Nucor's PEMB Drawings; however, is shown in a different location on the current Structural Drawings. Please confirm the location of this columns is acceptable. If so, please provide the foundation details required at these column locations.

#### Attachments:

Fleet Building - Drawings.pdf

#### Official Response

Awaiting an Official Response


All Replies: RESPONSE 2021 01 20:

BRIDGE CRANE COLUMNS (J) SHALL RECEIVE TYPE F6 FOOTINGS - REFERENCE DETAIL 8/S2-01 FOR SIZE AND REINFORCING FOR TYPE F6 COLUMN FOOTINGS.

AA COLUMNS ADDED FOR MEZZANINE SUPPORT SHALL BE COORIDNATED AND RELOCATED INSIDE OF WALLS FOR ADEQUATE SUPPORT OF MEZZANINE STRUCTURE. AA COLUMNS SHALL RECEIVE TYPE F3 FOOTINGS - REFERENCE DETAIL 8/S2-01 FOR SIZE AND REINFORCING FOR TYPE F3 COLUMN FOOTINGS

REVISED STRUCTURAL DRAWINGS WILL BE ISSUED IN REVISION 6, FOLLOWING THE RECEIPT OF REVISED METAL BUILDING DRAWINGS

MICHAEL SEGROVES - PROJECT ARCHITECT FOR GSB, INC. ARCHITECTS & PLANNERS

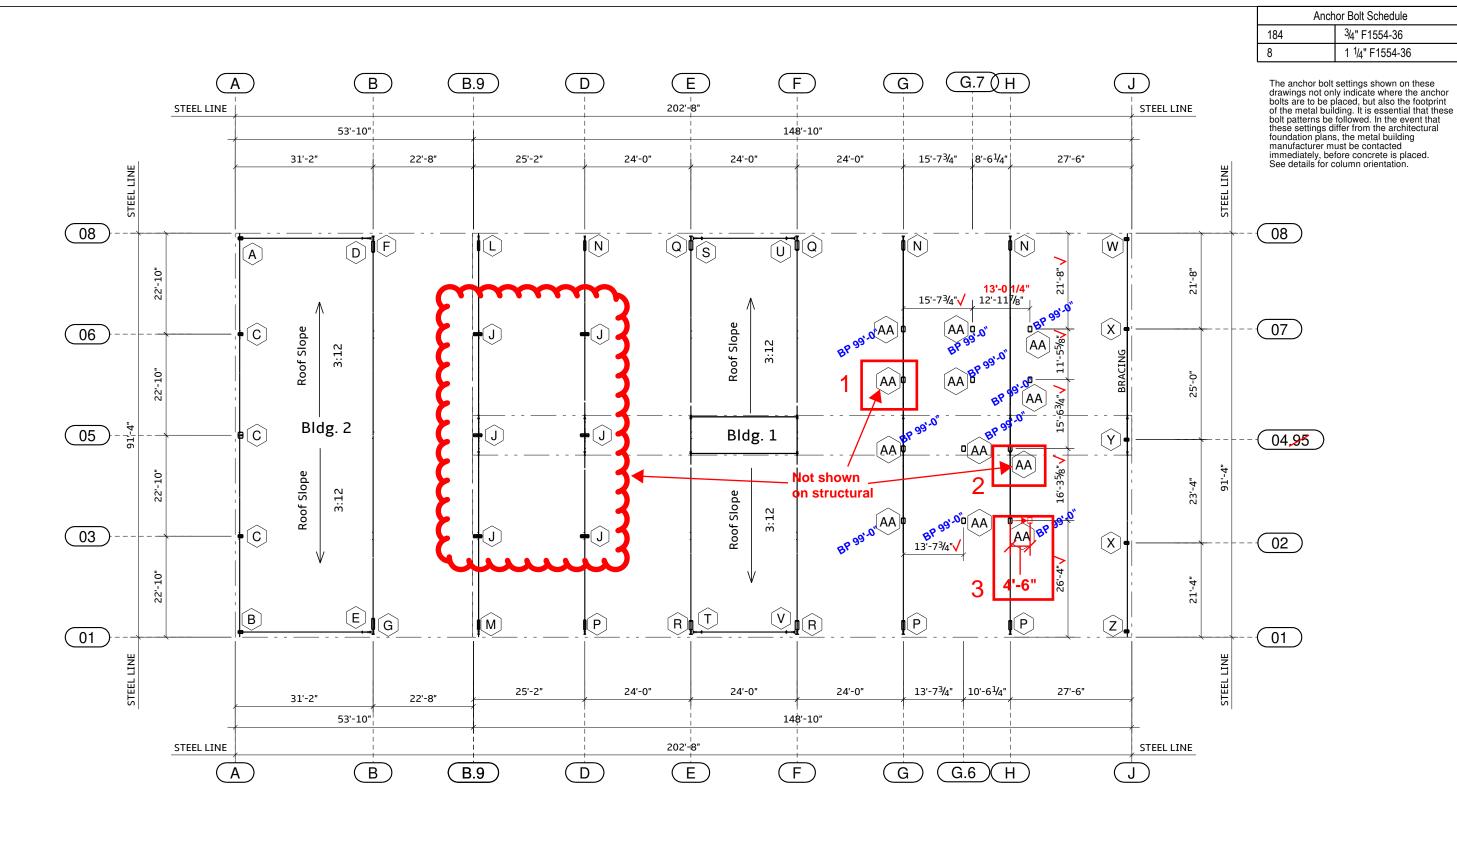

#### Notes:

The specified anchor rod diameter assumes F1554 grade 36 unless noted otherwise. Anchor rod material of equal diameter meeting or exceeding the strength requirements set forth on these drawings may be utilized at the discretion of the foundation design engineer. Anchor rod embedment length shall be determined by the foundation design engineer.

Metal building manufacturer is not responsible for project foundation design. The foundation design is the responsibility of a registered professional engineer, familiar with local site conditions.

All anchor rods, flat washers for anchor rods, expansion bolts, as well as all concrete/masonry embedment plates are not by metal building manufacturer.

This drawing is not to scale.

The anchor bolt locations provided by metal building manufacturer satisfy pertinent requirements for the design of the materials supplied by the metal building manufacturer. Please note that these requirements may not satisfy all anchor bolt concrete edge distance requirements depending on the details of the foundation design. Because foundation design is not within the metal building manufacturer scope of work, it is the responsibility of the qualified professional designing the foundation to make certain that sufficient concrete edge distance is provided for the anchor bolts in the details of the foundation

Finished Floor = 100'-0" Bottom of Baseplate Elevation = 100'-0" U.N.O. North Base Complex-Phase 1-Fleet Mainte Norman, Cleveland, OK Elite Star Construction, LLC Chickasha, OK JOB NUMBER T20E0456A OF

12/9/2020 12/18/2020


AAD DCR

BRA BRA

Anchor Bolts
Approvals

**DLCDDR**Bull DING SYSTEMS 6
600 Apache Trail
Terrell, TX 75160
Phone: (972) 524-5407
Fax: (972) 524-5417

SHEET TITLE
Anchor Bolt Plan

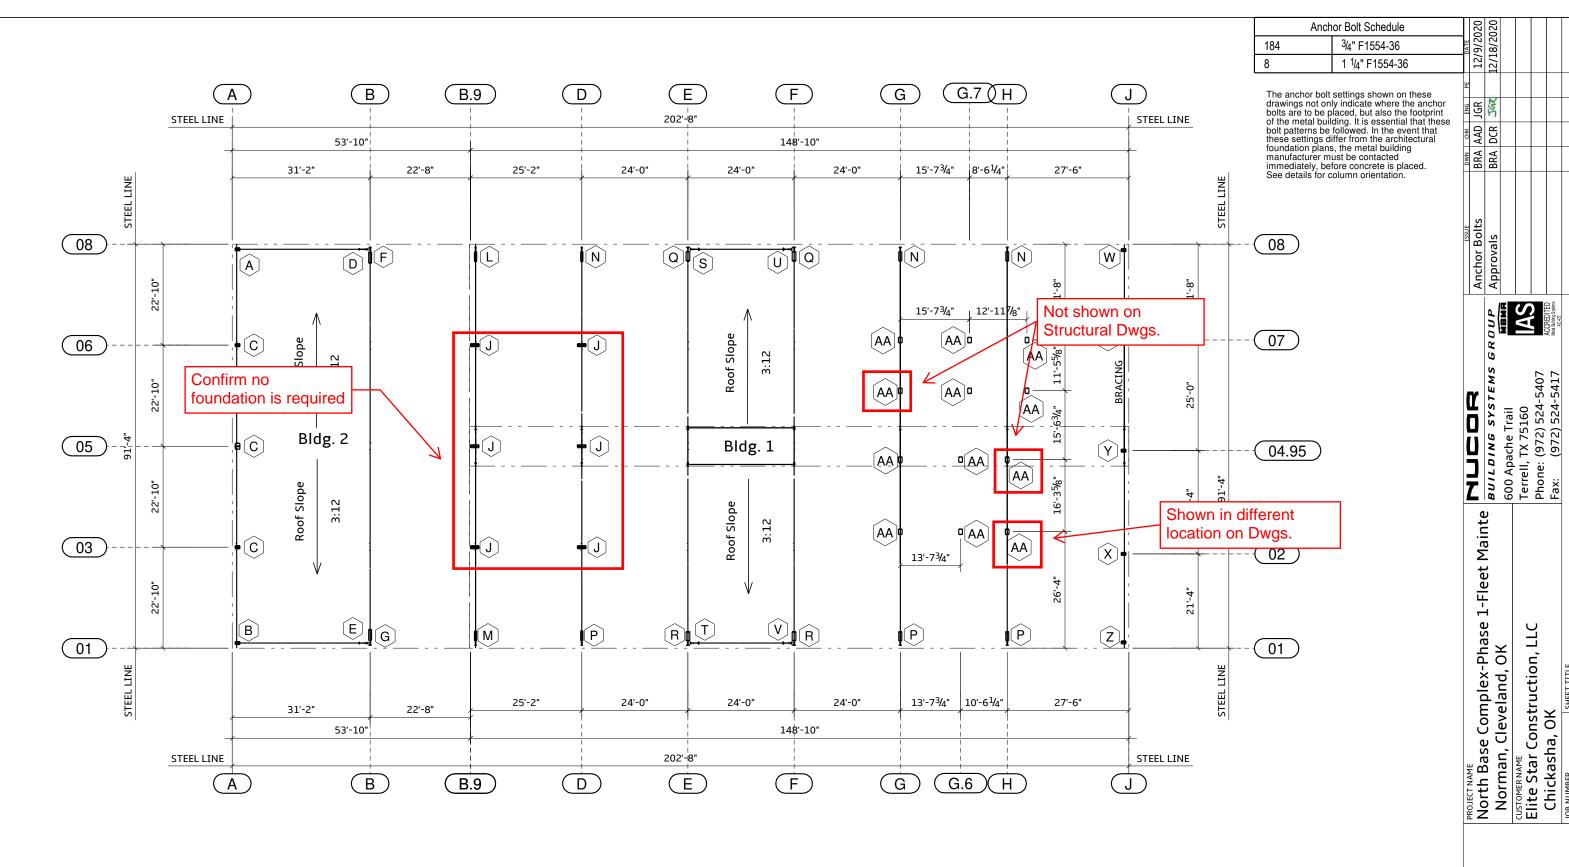

#### Notes:

The specified anchor rod diameter assumes F1554 grade 36 unless noted otherwise. Anchor rod material of equal diameter meeting or exceeding the strength requirements set forth on these drawings may be utilized at the discretion of the foundation design engineer. Anchor rod embedment length shall be determined by the foundation design engineer.

Metal building manufacturer is not responsible for project foundation design. The foundation design is the responsibility of a registered professional engineer, familiar with local site conditions.

All anchor rods, flat washers for anchor rods, expansion bolts, as well as all concrete/masonry embedment plates are not by metal building manufacturer.

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SHEET TITLE
Anchor Bolt Plan

JOB NUMBER T20E0456A

О

Finished Floor = 100'-0"

Bottom of Baseplate Elevation = 100'-0" U.N.O.

## ASI 001: BRIDGE CRANE ELECTRICAL COST REDUCTION

Job; NORTH BASE

Page #

em	Qty	Unit	Description	Hours	Ext	Material	Ext	
1			per ASI 001 change feed, breaker, and disconnect for 30 amps instead					
2			of the original 40amps. Delete circuit FN2B-38 also					
3								
4	270	e	(3 x 90") cost difference for the #10 wire deduct of .08 per foot			-0.08	-21.60	
5	180	e	(2 x 90') delete circuit FN2B-38, #12 wire Deduct wire, homerun conduit stays			-0.20	-36.00	
6	2		10' sticks of 1/2" conduit to homerun box will delete for FN2B-38			-4.60	-9.20	
7	1	e	1 man 2 hours labor deduct for the conduit deleted and manual motor starter	-2	-2.00			
8	1	e	total deduct for breaker, and disconnect change			-200.00	-200.00	
9								
10								
11								
12								
13								
14								
15								
16								
17								
18								
19								
20								
21	-							
22								
23								
4								
25								
85								
7								
8								
19								
00								
31								
32								

Totals -2.00 -266.80

Labor Hour Rate 60 **Total Labor** -120 **Total Material** -267 Profit Total Opening

Total Page 1 Total -387



## Horner Associates Engineers, Inc.

1306 Commerce Dr, Norman, OK 73071 email jhorner@haeinc.com Phone (405) 801-2528 Fax (405) 801-2529

## Architect's Supplemental Instructions

**Date:** December 30, 2020 **Project No.** 20-008

To: Michael Segroves, GSB

CC:

**Project:** North Base Complex - Phase 1, City of Norman, OK

Please include the following in your next ASI:

Item E1 REFERENCE THE CONTRACT DRAWINGS, SHEET E3-03: Change 480V, three phase branch circuit for overhead crane from 40A to 30A and eliminate the 120V control power circuit for a net credit to contract. If change does not result in a net credit this item shall be left as is.

- 1. Change disconnect switch from NF/60A to NF/30A.
- 2. Delete NEMA 4 requirement on the disconnect switch. NEMA 1 is acceptable.
- 3. Change circuiting from 3 #8, 1 #10 GND., to 3 #10, 1 #10 GND. Change associated circuit breaker from 3P60A to 3P30A.
- 4. Delete circuit FN2B-38 and associated manual motor starter & circuiting. Mark breaker as "Spare" in panel schedule.

# ALTERNATE (PARKS BUILDING): NON-PREVAILING WAGE CONFIRMATION



Flintco LLC (40-000) 2302 South Prospect Oklahoma City , Oklahoma 73129 Phone: (405) 670-6307 Project: 20136 - City of Norman - North Base Complex Phase 1 1310-1380 DA Vinci Street Norman, Oklahoma 73069

#### Prevailing Wage Exclusion on Parks Maintenance Building (Alt #1)

то:	Michael Segroves GSB, Inc. Oklahoma	FROM:	Phillip Gunderson Flintco, LLC - OKC 2302 S. Prospect Oklahoma City , Oklahoma 73129
DATE INITIATED:	11/10/2020	STATUS:	Open
REFERENCE:		DUE DATE:	11/19/2020
COST IMPACT:	No	SCHEDULE IMPACT:	No
LINKED DRAWINGS:		RECEIVED FROM:	Cory Rackley (Flintco, LLC - OKC)

#### **COPIES TO:**

Carolyn Bennett (GSB, Inc.), Geoff Evans (Planning Design Group), Randy Hill (ADG), Cory Rackley (Flintco, LLC - OKC), Jason A. Spencer (City of Norman), David Stanton (GSB, Inc.), Ethan Treisa (Flintco, LLC - OKC), Steve Tresemer (GSB, Inc.)

#### Question from Phillip Gunderson (Flintco, LLC - OKC) at 12:29 PM on 11/10/2020

As discussed previously with the City of Norman, the Parks Maintenance Building (Alt #1) will not be subject to Prevailing Wage.

Upon review, Flintco has been unable to find documentation validating the above mentioned Prevailing Wage exclusion.

Flintco requests formal confirmation and documentation of the Prevailing Wage exclusion on Parks Maintenance Building (Alt #1) be provided.

#### Official Response

Awaiting an Official Response

All Replies: Architect / Owner Response - 2020 / 11 / 12

Refer to attached letter from the City of Norman and associated documentation.

Per discussion in the pre-bid & pre-construction conferences, the Parks Maintenance Building construction and associated earthwork, subgrade, foundations, utilities and pavement within a ten (10') foot perimeter around the building are defined in the Bid Documents and Construction Documents as Add Alternate 01.

All funding for Add Alternate 01 comes from non-federal, City of Norman municipal sources. As no Federal funding will be utilized for this portion of the Contract, work bid and performed under Add Alternate 01, no federal requirements will apply to this portion of the work, including, but not limited to Davis-Bacon Prevailing Wage requirements. As noted in the pre-construction conference, the General Contractor (Flintco LLC) will track and bill this work on a separate payment application monthly to prevent the co-mingling of federal funds with this portion of the work.

Michael Segroves, AIA/AICP Project Architect - GSB



201 West Gray, Bldg. A · P.O. Box 370 Norman, Oklahoma 73069 · 73070

Phone: 405-366-5452 Fax: 405-366-5418

November 12, 2020

Kirk Mammen Vice President - Flintco 2302 S. Prospect Oklahoma City, OK 73129

Michael Segroves, AIA Director of Production – GSB, Inc. 3555 NW 58th Street, Suite 700W Oklahoma City, OK 73112

Subject: Prevailing Wage Exclusion on Parks Maintenance Building (Add Alternate 1)

Dear Mr. Mammen and Mr. Segroves,

This letter provides formal documentation that the Davis Bacon Prevailing Wage requirements listed in Section 00-73-00 and Section 00-73-46 of the City of Norman – North Base Complex, Phase 1 Project Manual apply to the Base Bid only. Add Alternate 1 (Parks Maintenance Building) is excluded from the Davis Bacon Prevailing Wage requirements because no federal funding will be used for this Add Alternate. Per the enclosed email correspondence with the FTA, because no federal funds are involved in the alternate bid for the Parks Maintenance Facility (stand-alone facility), no federal requirements would apply to the alternate bid and award.

All bidders were notified of this exclusion at the Pre-Bid meeting held on September 10, 2020. This letter serves to document the exclusion.

Sincerely,

Jason A. Spencer, P.E. Capital Projects Engineer

City of Norman Ph: 405-366-5315

Email: jason.spencer@normanok.gov

#### **Jason Spencer**

**Subject:** FW: 7358-2020-3 CARES Act Application

Attachments: Transit Operations & Maintenance Facility - Preliminary Schedule (06.04.20).pdf; Transit

Operations & Maintenance Facility - Preliminary Budget (06.04.20).pdf; Transit

Operations & Maintenance Facility - Site Map.pdf

From: Bartels, David (FTA) <david.bartels@dot.gov>

Sent: Tuesday, June 16, 2020 11:05 AM

To: Taylor S. Johnson < Taylor. Johnson @ Norman OK.gov >

Cc: Peschell, Daniel (FTA) <daniel.peschell@dot.gov>; Jason Spencer <Jason.Spencer@NormanOK.gov>; Shawn O'Leary

<Shawn.OLeary@NormanOK.gov>; Koski, Donald (FTA) <Donald.Koski@dot.gov>; Wallace, Laura (FTA)

<Laura.Wallace@dot.gov>; Ayala, Abel (FTA) <Abel.Ayala@dot.gov>
Subject: EXTERNAL EMAIL : FW: 7358-2020-3 CARES Act Application

Taylor –

I have reviewed the attached site plan, schedule and budget, as well as your responses to my comments below, with FTA Region 6 staff. We have identified 3 issues that Norman (City) should consider for this project and the grant application. The issues follow.

#### Issue 1:

The attached site plan shows a larger project, North Base complex, but also shows the improvements required for a fully functioning Transit Operations/Maintenance Facility. The facility scope includes areas for transit specific activities for operations, maintenance, maintenance support, employee parking, bus circulation, and bus parking, but also included is water, sewer, electric, drainage, site paving and a detention pond for the entire complex. As I understand it, there is no funding for the remaining areas of the complex, which are identified as funded separately or not included on the site plan, but the City plans to pay for the areas identified above and as shown on the site plan with FTA and local funding.

Under the federal cost principles at 2 CFR part 200, to be eligible for FTA funding, a project cost must be reasonable, allowable, and allocable. So, while the costs for the improvements that would benefit the whole project may be reasonable and allowable for both the transit and non-transit parts of the overall project, the FTA-eligible cost of those improvements may only be for those costs that are specifically allocable to the transit project. So, whatever portion of the parking, utilities, drainage, site paving, and the detention pond that can be reasonably attributed for the necessary use or benefit of the transit project would be eligible costs for the federal portion of the project.

There is no FTA guidance for determining what proportion of the costs for utilities, site paving and a detention pond for the entire complex are allocable to the Transit Operations and Maintenance Facility; however, the TrAMS budget must reflect the FTA-eligible costs allocable to the transit facility and transit uses. Any non-transit costs must be removed and/or shown as locally funded. Please document an estimate of the costs allocable to the transit facility and transit uses and submit it to FTA Region 6 for review/concurrence.

**Issue 2**: You communicated that Fire trucks will also be maintained in the facility so long as it does not interfere with the maintenance of the public transit fleet. As you may know, FTA considers this is an incidental use, which involves the non-transit use of transit property. This is a permissible use, but it is subject to the conditions for an incidental use that are described in FTA Circular 5010.1E, Award Management Requirements. Prior to the incidental use, the City must document compliance with FTA Circular 5010.1E.

#### Issue 3:

You communicated that the City potentially has bond elections going to the voters at the end of August, and if approved, the rest of the complex would be funded once the bonds were sold. The City is looking at how the non-transit portions of the complex can be bid as alternates to the base bid (transit operations/maintenance facility) should additional local funding become available.

The City should be able to develop a solicitation where the non-transit portions of the complex can be bid as alternates to the base bid (transit operations/maintenance facility) subject to the condition of future funding becoming available. In addition, since some of the improvements to the overall complex (as discussed above) would be eligible and allocable costs, this means that a contract to construct the overall complex would need to comply with all applicable federal procurement requirements. This is also referred to as federalizing the project.

If the city did not want federal requirements to apply to the allocable improvements discussed above (even though the allocable improvements would be eligible costs), The City could issue a solicitation that makes it clear that the federal requirements would only apply to the O&M facility and the City would locally fund the remainder of the overall complex. As a result, if no federal funds are involved in an alternate bid, which might include the Parks Maintenance Facility (stand-alone facility), no federal requirements would apply to the alternate bid and award. This issue, which is more of a potential scenario, does not need to be addressed in the TrAMS application at this time.

To expedite processing of the TrAMS application, I am available to discuss these issues with you and your staff this week. Please let me know what dates/times work you.

Thank you,

David Bartels FTA Region 6 (817) 978-0572

From: Taylor S. Johnson [mailto:Taylor.Johnson@NormanOK.gov]

Sent: Friday, June 5, 2020 11:41 AM

**To:** Bartels, David (FTA) < <u>david.bartels@dot.gov</u>>

Cc: Peschell, Daniel (FTA) <daniel.peschell@dot.gov>; Jason Spencer <Jason.Spencer@NormanOK.gov>; Shawn O'Leary

<Shawn.OLeary@NormanOK.gov>

Subject: RE: 7358-2020-3 CARES Act Application

David,

Please see our response to your comments below in red.

- The TrAMS application in the subject line does not include an ALI for construction of a transit operations/maintenance facility. Does the application need to be updated?\
  - Application subject line updated.
- Can you provide me a detailed description of the "project"? This might clear up much of my confusion. Nowhere in the site plan, schedule and budget do you use "transit operations/maintenance facility".
  - The Fleet Maintenance building is the transit operations/maintenance facility. We will rename it on the site plan. In that facility there is an admin portion (on the north side) that will house transit operations (managers, dispatchers, schedulers, office admins, etc.) and will include restrooms, lockers, breakroom, driver's lounge, conference/training room, etc. The majority of the building are the maintenance bays (south of the admin/operations portion) that will be used to maintain the public transit fleet. Fire trucks will also be maintained here so long as it does not interfere with the maintenance of the public transit fleet. South of the maintenance bays will be a parts room, tool room, and lube room. Finally, the last part of the building is a cleaning bay that will be used for interior cleaning of the buses and some minor power washing.

## **DELAY DAYS**

Norman North Base - Phase 1: Weather Day Log

Month and Year	Weather Days Incurred	Actual Weather Days Claimed
November-20	3	3
December-20	10	10
January-20	7	7
February-20	0 (as of 02/05)	0 (as of 02/05)
March-20		
April-20		
May-20		
June-20		
July-20		
Total (Days)	20	20

	<u>Date</u>	<u>Days</u>	<u>Reason</u>
1	23-Nov-20	1	Wet & Muddy Conditions
2	24-Nov-20	1	Rain, Wet & Muddy Conditions
3	25-Nov-20	1	Wet & Muddy Conditions
4	3-Dec-20	1	Rain, Wet & Muddy Conditions
5	4-Dec-20	1	Wet & Muddy Conditions
6	14-Dec-20	1	Snow, Ice, Wet & Muddy Conditions
7	15-Dec-20	1	Snow, Ice, Wet & Muddy Conditions
8	16-Dec-20	1	Snow, Ice, Wet & Muddy Conditions
9	17-Dec-20	1	Wet & Muddy Conditions
10	18-Dec-20	1	Wet & Muddy Conditions
11	29-Dec-20	1	Rain, Wet & Muddy Conditions
12	30-Dec-20	1	Rain/Snow, Ice, Wet & Muddy Conditions
13	31-Dec-20	1	Rain/Snow, Ice, Wet & Muddy Conditions
14	4-Jan-21	1	Wet & Muddy Conditions
15	5-Jan-21	1	Wet & Muddy Conditions
16	6-Jan-21	1	Wet & Muddy Conditions
17	7-Jan-21	1	Wet & Muddy Conditions
18	8-Jan-21	1	Wet & Muddy Conditions
19	25-Jan-21	1	Rain, Wet & Muddy Conditions
20	26-Jan-21	1	Wet & Muddy Conditions

Note: Flintco also incurred a two (2) working day delay due at the beginning of the project due to a delay receiving the Permitted Utility Drawings.

Days of Delay:

November 2, 2020 November 3, 2020