#### Exhibit A

Plan or Model No.:	
Property Address or Legal Description: 112 & 114 W. Johnson St and 815 N. Stewart Ave, Norman, Ok 73069	
Owner(s): NORMAN HOUSING AUTHORITY	
Builder:	
GENERAL CONDITIONS	
These specifications cover labor and materials necessary for the construction of a single family residence according to the aforementioned Model No. or plan submitted, to be erected for said buyer at the above address. All the work is to be executed in a workmanlike manner in accordance with accepted standards of the building industry in this area, local building codes, and the plans and specifications. Or Equal with approval applies	
All excess material left after completion of construction shall remain the property of the Builder.	
1. EXCAVATION AND LAND CONDITIONS:	
Expenses incurred because of soil conditions such as quick-sand, rock, trees, including necessity for additional excavating, providing fill or cutting of lot, grading, removal of excess ground, additional footings, reinforcing, piers additional depth of foundation wall, pumping, extra waterproofing of basement or diversion of water because of springs, wells, seepage, underground drainage lines, etc., shall be paid for by Owner.	,
Allowance for excavation and site clearing, if applicable:	
2. BACKFILL AND GRADING:	
Builder shall be the authority for placement of building on lot and establishment of building grade as required by municipal authority. Builder shall not be responsible for settling of any backfill after grading. If any additional fill is required due to unstable soil conditions, it shall be paid for by the Owner.	
3. FOOTINGS: Trench & stem foundation	
Concrete footings for walls and piers shall be of sizes as shown on the plans and to meet local building codes.	
4. FOUNDATION WALLS:	
Foundation walls shall be as shown on the plans. Material: poured concrete @ 3,500 psi. The Builder does not warrant against dampness or water caused by natural conditions of soil, drainage, hydrostatic pressure, condensation or climatic conditions.	
Foundation wall height shall be: 12"	
BUILDER INITIAL:	

#### 5. BASEMENT FLOOR: N/A

Basement floor shall be as shown on the plans, 3" (average thickness) poured concrete slab with "Fibermesh" additive. Builder shall not be responsible for hairline cracks that may occur in the basement floor. Saw joints will be installed to control cracking. Builder will repair cracks exceeding maximum tolerances (3/16" width) by surface patching.

#### 6. STEEL:

Support columns and steel beams shall be furnished and installed as shown on the plan.

7. MASO	NRY EXTERIOR	R WALLS AND EX	XTERIOR CHASE:
Brick veneer in the base c		\$375.00	per thousand brick. Allowance is for material only; labor is included
			en size brick. Using standard or king size brick may result in additional I gray may require additional charges to the Owner.
8. FIREF	PLACE/CHIMNE	Y: N/A	
Chimney sha	all be constructed	as shown on the	plans.
Fireplace, typ	<u>oe/size:</u>		
	Metal fireplace	e:	
	Masonry firepl	ace; lining materia	al:
Exterior chas	<u>se:</u>		
	Facing:		
Flue type:			
	Metal flue:		
	Masonry flue:		
	Doors, if any (	describe):	
Interior treatr	ment and mantel:	<u>:</u>	
	included in the king size brick	base contract. La	per thousand brick. Allowance is for material only; labor is abor cost in budget reflects installation of queen size brick. Using standard or ditional charges. Mortar selections other than standard gray may require.
	Tile (see spec	#29).	
	Cultured stone	e to be priced at ti	me of selection.
Fir	replace hearth m	aterial:	□ Flush □ Raised
Fir	replace hearth si	ze:	
Fir	replace surround	material:	
Fir	replace face ope	ning size:	
F	ireplace Mantel		
В	BUILDER Initial		

<u>9.</u>	WALKS AND DRI	<u>VEWAYS:</u>	All concre	<u>te to be 3500 p</u>	<u>osi</u>					
			16 feet			; length:	As show	As shown on plans		
			material: Sand			; thickness:	4"			
			ing material: Concrete, 3500 #			; thickness:	4"	_ ; reinforcii	ng:	
	Culvert									
	Front walk material:		Concrete 3500#	e ; length:	See Plan	; width:	4 ft	; allowar —	nce:	
	Service walk materi	al:	Concrete 3500#	e ; length:	See Plan	; width:	See Plan			
	Steps material:		N/A			; number	r of steps	: None		
	Stoops: front:		See Plans	; rear:	See Plans	; other:	Termit	e pretreat		
<u>10.</u>	EXTERIOR WALL	FRAME:								
	Lumber: wood studs	S:	2x6	; species:	#2 WCDF	; spacing: —	24"	o.c.		
	Height of exterior w	alls: first flo	oor: 9 feet			; second	floor:	n/a		
	Sheathing:	4x9 Zip W	/all taped	; thi	ckness:	7/16		; width:	48"	
	Siding: type:	Cement fi	ber, see pla	ns ; species	3:			; grade:		
	size:	See pla	ns	; exposu	ire: Se	ee plans	; f	astening:	Nail	
	Brick veneer:	See plans	3							
<u>11.</u>	FLOOR FRAME:									
	Concrete Slab: 4"	3500 psi ı	nix with 5-7	% A.E. over 4	" sand f	ill. Compacte	d & term	ite pretreat		
	Species:			; size: firs	t floor:			; spacing:		
				size: seco	ond floor	:		; spacing:		
<u>12.</u>	SUBFLOORING:	N/A								
	Туре:			; size:						
<u>13.</u>	INTERIOR WALL	FRAME:								
	Species: #2 WC	CDF				; size: 2x4		; spacing:	16" o.c.	
	Height: first floor:	Se	e Plan			; second floor:	N/A	4		
	All plates, sills & s	leepers in	contact wit	th concrete to	be treat	ed yellow pin	e materia	al.		
<u>14.</u>	CEILING FRAME	<u>:</u>								
	First floor:	WCDF #2	<u> </u>		; size	Meet code		; spacing:	16" o.c.	
	Second floor:							; spacing:		
BUIL	LDER INITIAL:									

<u>15.</u>	ROOF SYSTEM:
	Type: 6/12 pitch ; size: 2 x 6 cut roof ; spacing: 24" o.c.
<u>16.</u>	ROOF SHEATHING:
	Type: Solar OSB with clips ; size: 4'x8' ; spacing: Solid
<u>17.</u>	ROOFING:
	Type: GAF Timberline HD Composition ; color: Weathered Wood
	Warranty/grade: 30 Year ; underlayment: Synthetic
18.	BUILT UP OR FLAT ROOFING: N/A
	Number of plies: ; weight: ; surface material:
<u>19.</u>	EXTERIOR DOORS AND TRIM:
	Entrance doors (type/brand): Front: 3068 Fiberglass
	Garage/service: _ 3068 Fiberglass, 6 Panel
	House to garage: 3068 Fiberglass 6 panel
	Weatherstripping: In Jamb (prehung)
	Combination storm and screen doors:
	Sliding patio doors/French hinged doors: 2868 Fiberglass full view with blinds
	Exterior millwork: Smart Trim
	Shutters, railings, louvers: See Plan
<u>20.</u>	WINDOWS: Meet City of Norman energy & building code
	Type: Vinyl single hung ; brand: ; clad exterior color: White
	Low E: X Yes D No Storms/screens: 1/2 ; color: White
	Basement windows: N/A
<u>21.</u>	PLUMBING:
	House drain inside: X PVC
	House sewer (outside): X PVC □ Other:
	Water piping: ☐ Copper X Other: PEX
	Sill cocks (number/location): 2 Woodford #19 One front, one back
	Gas service: x Utility company  Other:
BUIL INITI	LDER IAL:

Water supply:		X	Public	Community well		Private well	Allow	ance:
Sewage disposal: X Public		Septic		Allowance:				
☐ Water to humidifier		Clear water with sump pump		Х	Gas to furnace			
Χ	Gas to water he	eater		☐ Gas to dryer			Gas rough-in to fireplace	
	Log lighter at fir	epla	ce	Gas to range				Gas to exterior grill
X Water to refrigerator		Utility floor drain; location per plan		X	Dishwasher: hook up only			
	Third water line	to s	oftener	Sanitary pit with su	ımp p	oump		
Finishes: Satis Chroma Dalta								

Finishes: Satin Chrome Delta

FIXTURE	MAKE	MODEL #	COLOR	NOTES
Kitchen:				
Sink	2 compartment 20ga		Stainless steel	
Sink faucets	Delta	#9178-AR-DST "Leland"	Artic Stainless	Pull down
Disposal		1/2 HP		
Drain cover			Stainless	
Hall Bathroom:				
Lavatory	21" oval		White china	
Lav. faucet	Delta	#2532LF-SSMPU "Woodhurst" 4"cc	Satin Chrome	
Toilet	Mansfield	#135-160 Alto EB	White	Comfort seats EB white
Bathtub:	Lasco		White tile look	Tub & surround
Tub/shower faucet	Delta	#T14432-SS "Woodhurst"	Satin Chrome	
Master Bathroom:				
Bath tub	N/A			
Tub faucet	N/A			
Lavatory	21" oval		White china	
Lav. Faucet(s)	Delta	#2532LF-SSMPU "Woodhurst" 4"cc		
Toilet	Mansfield	#135-160 Alto EB	White	Comfort seats EB white
Shower matl./type	Ceramic tile			Schluter System
Shower faucet	Delta	#T14232-SS "Woodhurst"	Satin Chrome	
Other:				

BUILDER ITIAL:	
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Finishes (cont'd):

FIXTURE	MAKE	MODEL #	COLOR	NOTES
Bath #2:				
Tub/Shower				
Tub faucet				
Lavatory				
Lav. faucet				
Toilet				
Other:				
Bath #3:				
Tub/Shower				
Tub faucet				
Lavatory				
Lav. faucet				
Toilet				
Other:				
Plumbing:				
Other:				
Utility Room:				
Laundry sink				
Faucet				
Other:	Recessed valves	And drain box		
Other:				
Water Softener				
Distiller				
Other:				

BUILDER	
INITIAL:	

#### 22. HEATING/VENTILATING/AIR CONDITIONING/SHEET METAL:

	Size, capacity and output shall be determined by heat loss calculation per state energy code.							
	Warm air furnace (make and model): 84,000 BTU natural gas 95%							
	Number of air ducts: Provide layout Number of return inlets: 2							
	Warm air duct material: G.I. & R 8 Fuel: X Natural gas ☐ Geothermal ☐ Electric flex							
	Air conditioner (make, model, tons): 2.5 ton 16 SEER							
	Zone system areas:							
	Humidifier (make and model): N/A							
	Air filter (make and model): Filter grills							
	Thermostats (make and model): Digital							
	Clothes chute: ☐ Yes X No Vented hood: X Yes ☐ No							
	Downdraft: ☐ Yes X No Bath Heat/Vent/Light _2							
	Gutters and downspouts: Material: Alum. Entire house Size: 5 1/2 Color: To be determined							
	Flashing material: Galvanized sheet metal							
	Other sheet metal work:							
	Other HVAC: Recessed dryer vent box							
23.	ELECTRICAL WIRING:							
	Service type: x Underground  Overhead Size of service: 200 amp							
	Type of wiring: Non metallic cable	_						
	Wiring to be provided (no. of outlets—lights, switches and receptacles): X Per plan Per code plus the following special outlets:							
	X Dryer 220 volts ☐ Bath vent—fan only ☐ Air cleaner							
	X Air conditioning X Bath vent—Heat/Vent/Light 2							
	☐ Water well pump X Exterior outlets 3 ☐ Street lamp							
	X Dishwasher X Chimes							
	X Furnace							
	X Range 220 volt ☐ Special outlets in basement ☐ Wire whirlpool							
	X CATV jack(s) 5 x Telephone jacks							
	☐ Water softener: wire for owner-provided unit X Low voltage wiring for garage door openers							
	Recessed light housings and trims shown on plan to be supplied by electrician.							
	Outlets to be duplex, color: White or ivory							
BUIL INITI	DER							

<u>24.</u>	SECURITY/VACUUM/AUDIO VISUAL WIRING: N/A	
	Security:	or Allowance:
	Vacuum:	or Allowance:
	Audio visual:	or Allowance:
<u> 25.</u>	GARAGES:	
	Garage door type: 8 x 7 Steel Panel	
	Operators: 1 Number: 1 Make/mod	del: ½ hp 2 remotes
	Garage finish: _Textured and painted	
	Floor drains:	
<u> 26.</u>	INSULATION:	
	Exterior walls: R-19	
	Ceilings: R 38 Blown Fiberglass	
	Other: R 30 Fiberglass Bats	
	Vapor barrier type: Tyvek Drainage house wrap at siding	
<u>27.</u>	DRYWALL:	
	Thickness: Walls: 1/2 Ceilings: ½ Tape, joint ce	ment and one spray coat. Metal outside corners.
	Attached garage firewall to be fire rated as shown on plan. Thick	kness:
		Hand texture & Paint
28.	CERAMIC TILE:	
	Ceramic tile labor for the areas below is included in the base pri adhesive) allowance is listed below.	ice of the home. Material-only (tile, grout,
	Master bath: \$4.00	
	Hall Bath	
	Bath #3:	
	Kitchen:	
	Utility room:	
	The allowance for ceramic tile material only for all areas specific	ed above is: \$4.00
<u> 29.</u>	FINISH HARDWARE ALLOWANCE:	
	Type: BHP	
	All bathrooms and master bedroom to have privacy locks.	Front Door: BHP
	Deadbolt locks on all exterior doors. All keyed alike	
BUIL	.DER	

#### 30. FINISH FLOORING: Vinyl plank flooring allowance of \$3.25 / ft. tile and glue


	ROOM/AREA	FII	NISH FLOOR		SUBFLOOR	NOTES
	Entry			Concre	te	
	Breakfast Room					
	Halls					
	Family Room					
	Kitchen					
	Utility Room					
	Study					
	Bath #2					
	Master Bathroom					
	Master Bedroom					
	Secondary Bedrooms					
	Gallery					
	Dining Room					
	<b>y</b> -					
	Staircase					
	Notes: Vinyl plank for e	ach room				
	Total allowance for carp		or and material)	:		
	Total allowance for tile r					
	Total allowance for hard		ring (lahor and	material)·		
31.	INTERIOR DOORS AN		g (lasor and	atoriarj.		
<del></del>			0 1 1	<b>N</b> 4 4 1 1		TI: 1 4 0/0"
		· —	C slab	Material:	Oak veneer	Thickness: 1-3/8"
	•	ype:		Material:	0-1	Thickness:
		ype: <u>D</u>		Material:	Oak	Size: 2 1/4
			-4-11	Material:		Size:
			etail	Material:	Oak	Size: 3 1/4
		ype:		Material:		Size:
		ype:		Material:		Size:
	Windows to have:	×	,			g—picture framed
	Doorway openings to h		Drywall retu	ırns	■ Wood casing	g—picture framed
	Special doors: Loca	ition:				Size:
	Ту	pe:		Material:		Thickness:
	Special trim:					
	Wall paneling:					
D	DED					
BUIL INITI						

<u>32.</u>	STAIR	S:	N/A										
			Site fa	abricated			M	lill made					
	Style:		Over	the post trac	ditional		Ρ	ost to po	ost				
	Main Stair:											Brand/manufacturer:	
	Tr	Treads Material:		Material:						Paint		Stain	
	Ri	Risers		Material:						Paint		Stain	
	St	Stringers		Material:						Paint		Stain	
	Handrail		Material:	:					Paint		Stain	Style:	
	Ва	aluste	er	Material:						Paint		Stain	Style:
	Ne	ewel	post	Material:						Paint		Stain	Style:
	Basem	ent S	Stair:										
	Treads		3	Material:									
	Ri	isers		Material:									
	St	tringe	ers	Material:									
	Ha	andra	ail	Material:									
	W	alls/		Material:									
	Interior	Bas	ement	Stair:	<b>O</b> pen		_	Closed					
33.	CABIN	IETS	<u>:</u>										
	Total al	lowa	nce for	cabinets:	In	clude	ed i	n Price	ors	specify:			
	Ki	Kitchen: Material: Oak					Doo	Door fronts: Raised panel					
	Vanities:		Material:	erial: Oak				Door fronts:		R	Raised panel		
	Utility: Material		Material:	Oak			Doo	Door fronts: Raised panel			nel		
	Ha	ardw	are:	Knobs:	\$2.50 e	ach			Pul	ls:	_\$4	1.00 eacl	h
<u>34.</u>	COUN	TER	/VANIT	Y TOPS:									
	Total allowance for counter/vanity tops:												
	Countertop type: Plastic laminate, installed					full spla	sh ir	n kitchen,	4" b	athroom	s. \$28.00 / lineal ft.		
				_									
<u>35.</u>	SHOW	/ER E	ENCLO	SURES:									
	Total allowance for shower enclosures:												
	Specify type for each: Master Bath:  Bath #2:			Bath:	N/A	4							
				Bath #2	2: \$200.00 Obsc			ure g	ure glass				
	Other:			Other:									
						-							
BUIL INITI	.DER AL:	. <u>-</u>											

<u>36.</u>	MIRROR	<u>S:</u>									
	Total allow	ance for mirrors: \$300 installed (1/4" plate installed with clips									
	Specify typ	e for each: Master Bath:									
		Bath #2:									
		Bath #3:									
		Powder Room:									
		Other:									
<u>37.</u>	BATHRO	OM ACCESSORIES:									
	\$210.00, 4	0, 4 towel bars and 2 toilet paper holders.									
38.	LIGHTING FIXTURES:										
	Total allowance for all lighting fixtures and bulbs: \$1,500  Recessed lighting fixtures and trims and Heat/Vent/Lights shown on plans are included in the contract p Light bulbs for both recessed fixtures and decorative fixtures to be provided by lighting supplier and cha to lighting fixture allowance. Under counter lights included.										
39.	PAINTING	PAINTING:									
	Exterior:	Trim/si 1 primer, coats exterior paint or stain. Number of colors allowed: 2									
		ding: 1 finish									
Caulking shall be applied on exterior where windows, doors and masonry meet siding											
	Interior:	Walls: Flat									
		Ceilings: Flat									
		Number of pastel colors allowed: 1									
		Stained woodwork shall be sealed and sanded. 2 coat(s) of varnish shall be applied. +1									
		Painted woodwork shall be sealed and primed. 2 coat(s) of satin enamel shall be applied.									
<u>40.</u>	APPLIANCES:										
	Total allowance for appliances: \$1,000  This allowance assumes the following appliances are to be included in the contract price (specify make, model and color):										
Range: 30" electric											
	Microwave	30" over range, vented									
	Dishwashe	24" under counter									
	Oven:										
	Refrigerato	r									
	Washer:										
	Dryer:										
	Other:	30" vented hood									
BUIL INITI											

#### 41. LANDSCAPING/PLANTING:

Total allowance for landscaping:	\$800.00 installed with price to include solid		ot including sod. Contract
40 EENOINO			
42. FENCING:			
43. OTHER:			
Full guttering			
44. CLEANING:			
Builder to provide labor, material a all windows, removal of debris, cle and basement.			
The foregoing specifications consist of below. These specifications are an add below-listed property.			
Builder:	Date	Owner:	Date

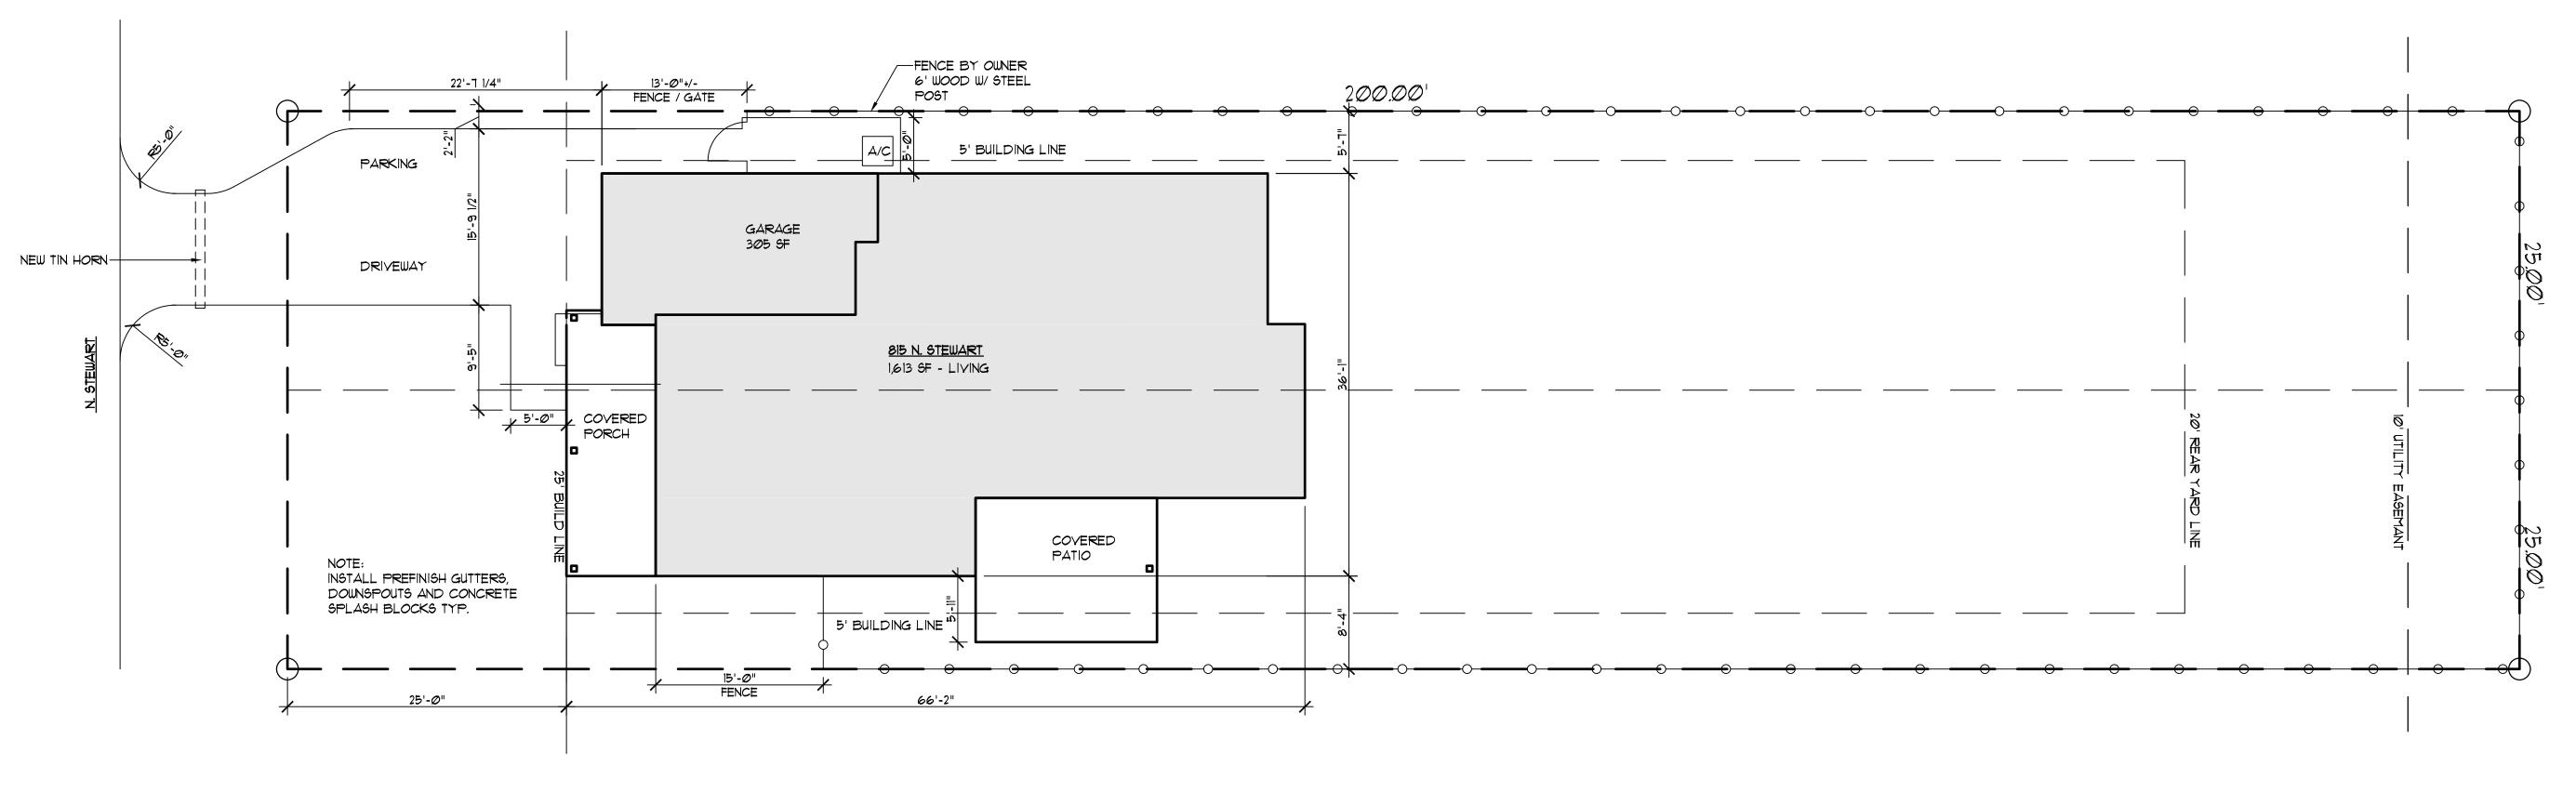



Sea

Project:

815 N. Stewart
Norman, OK.

Issue Date: 7/23/20 PERMIT


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112 W. Johnson St. Norman, OK.

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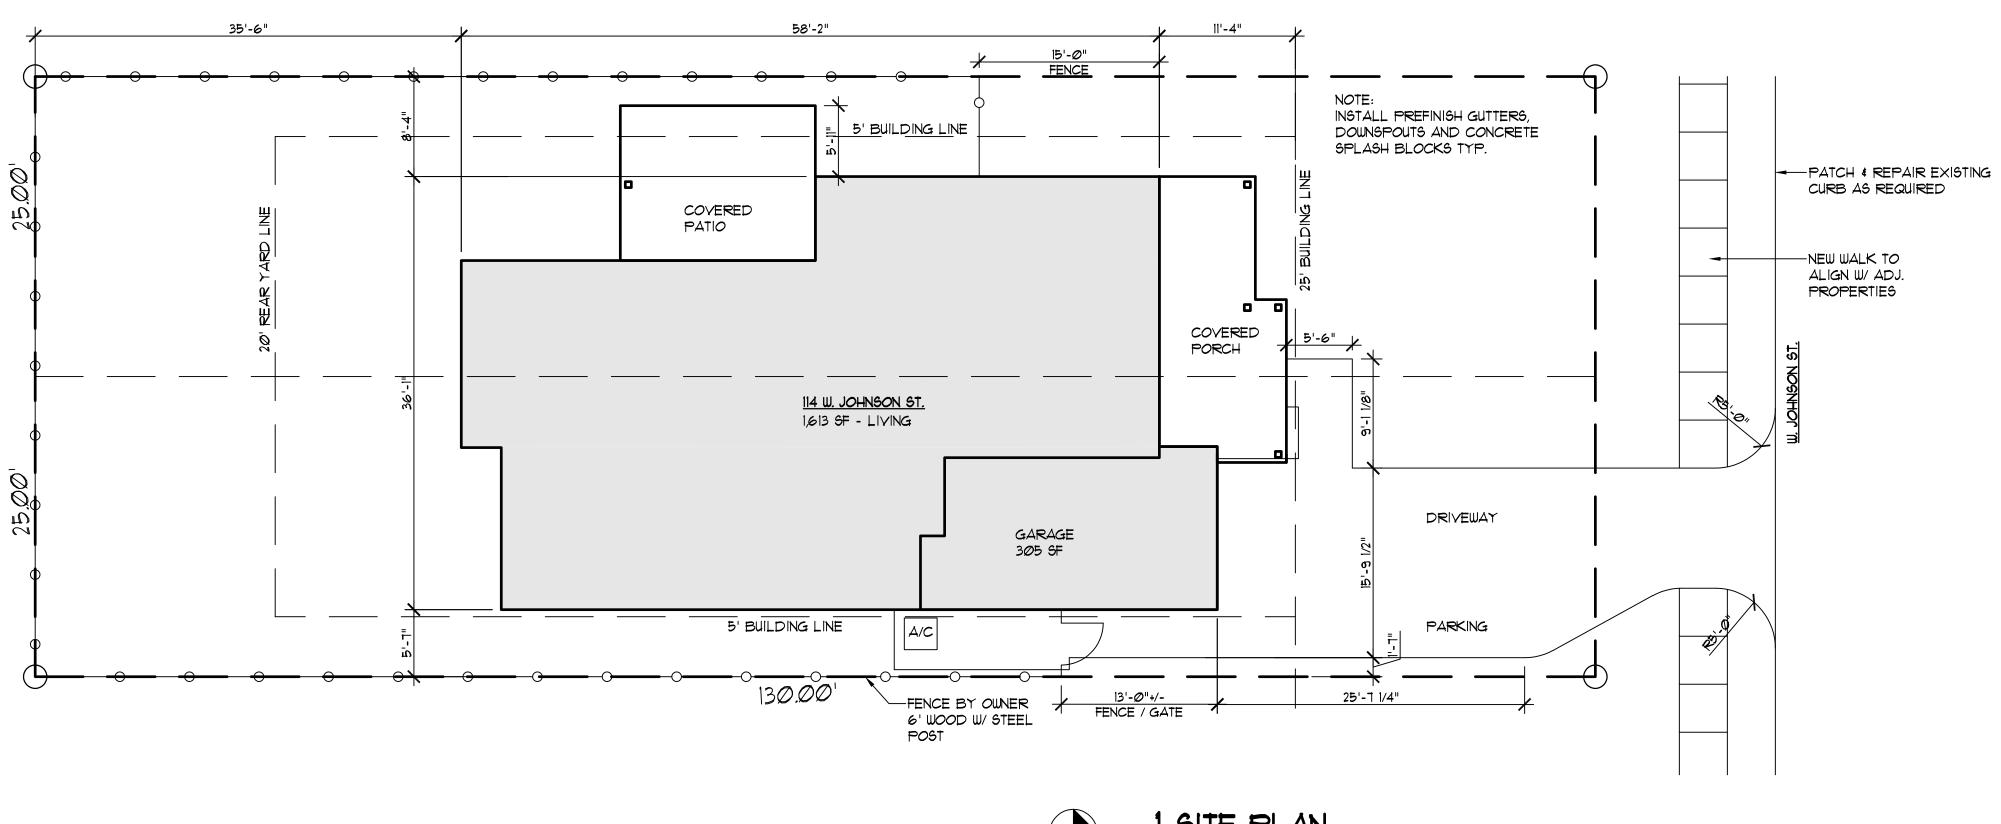
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**Johnson** Norman, OK.


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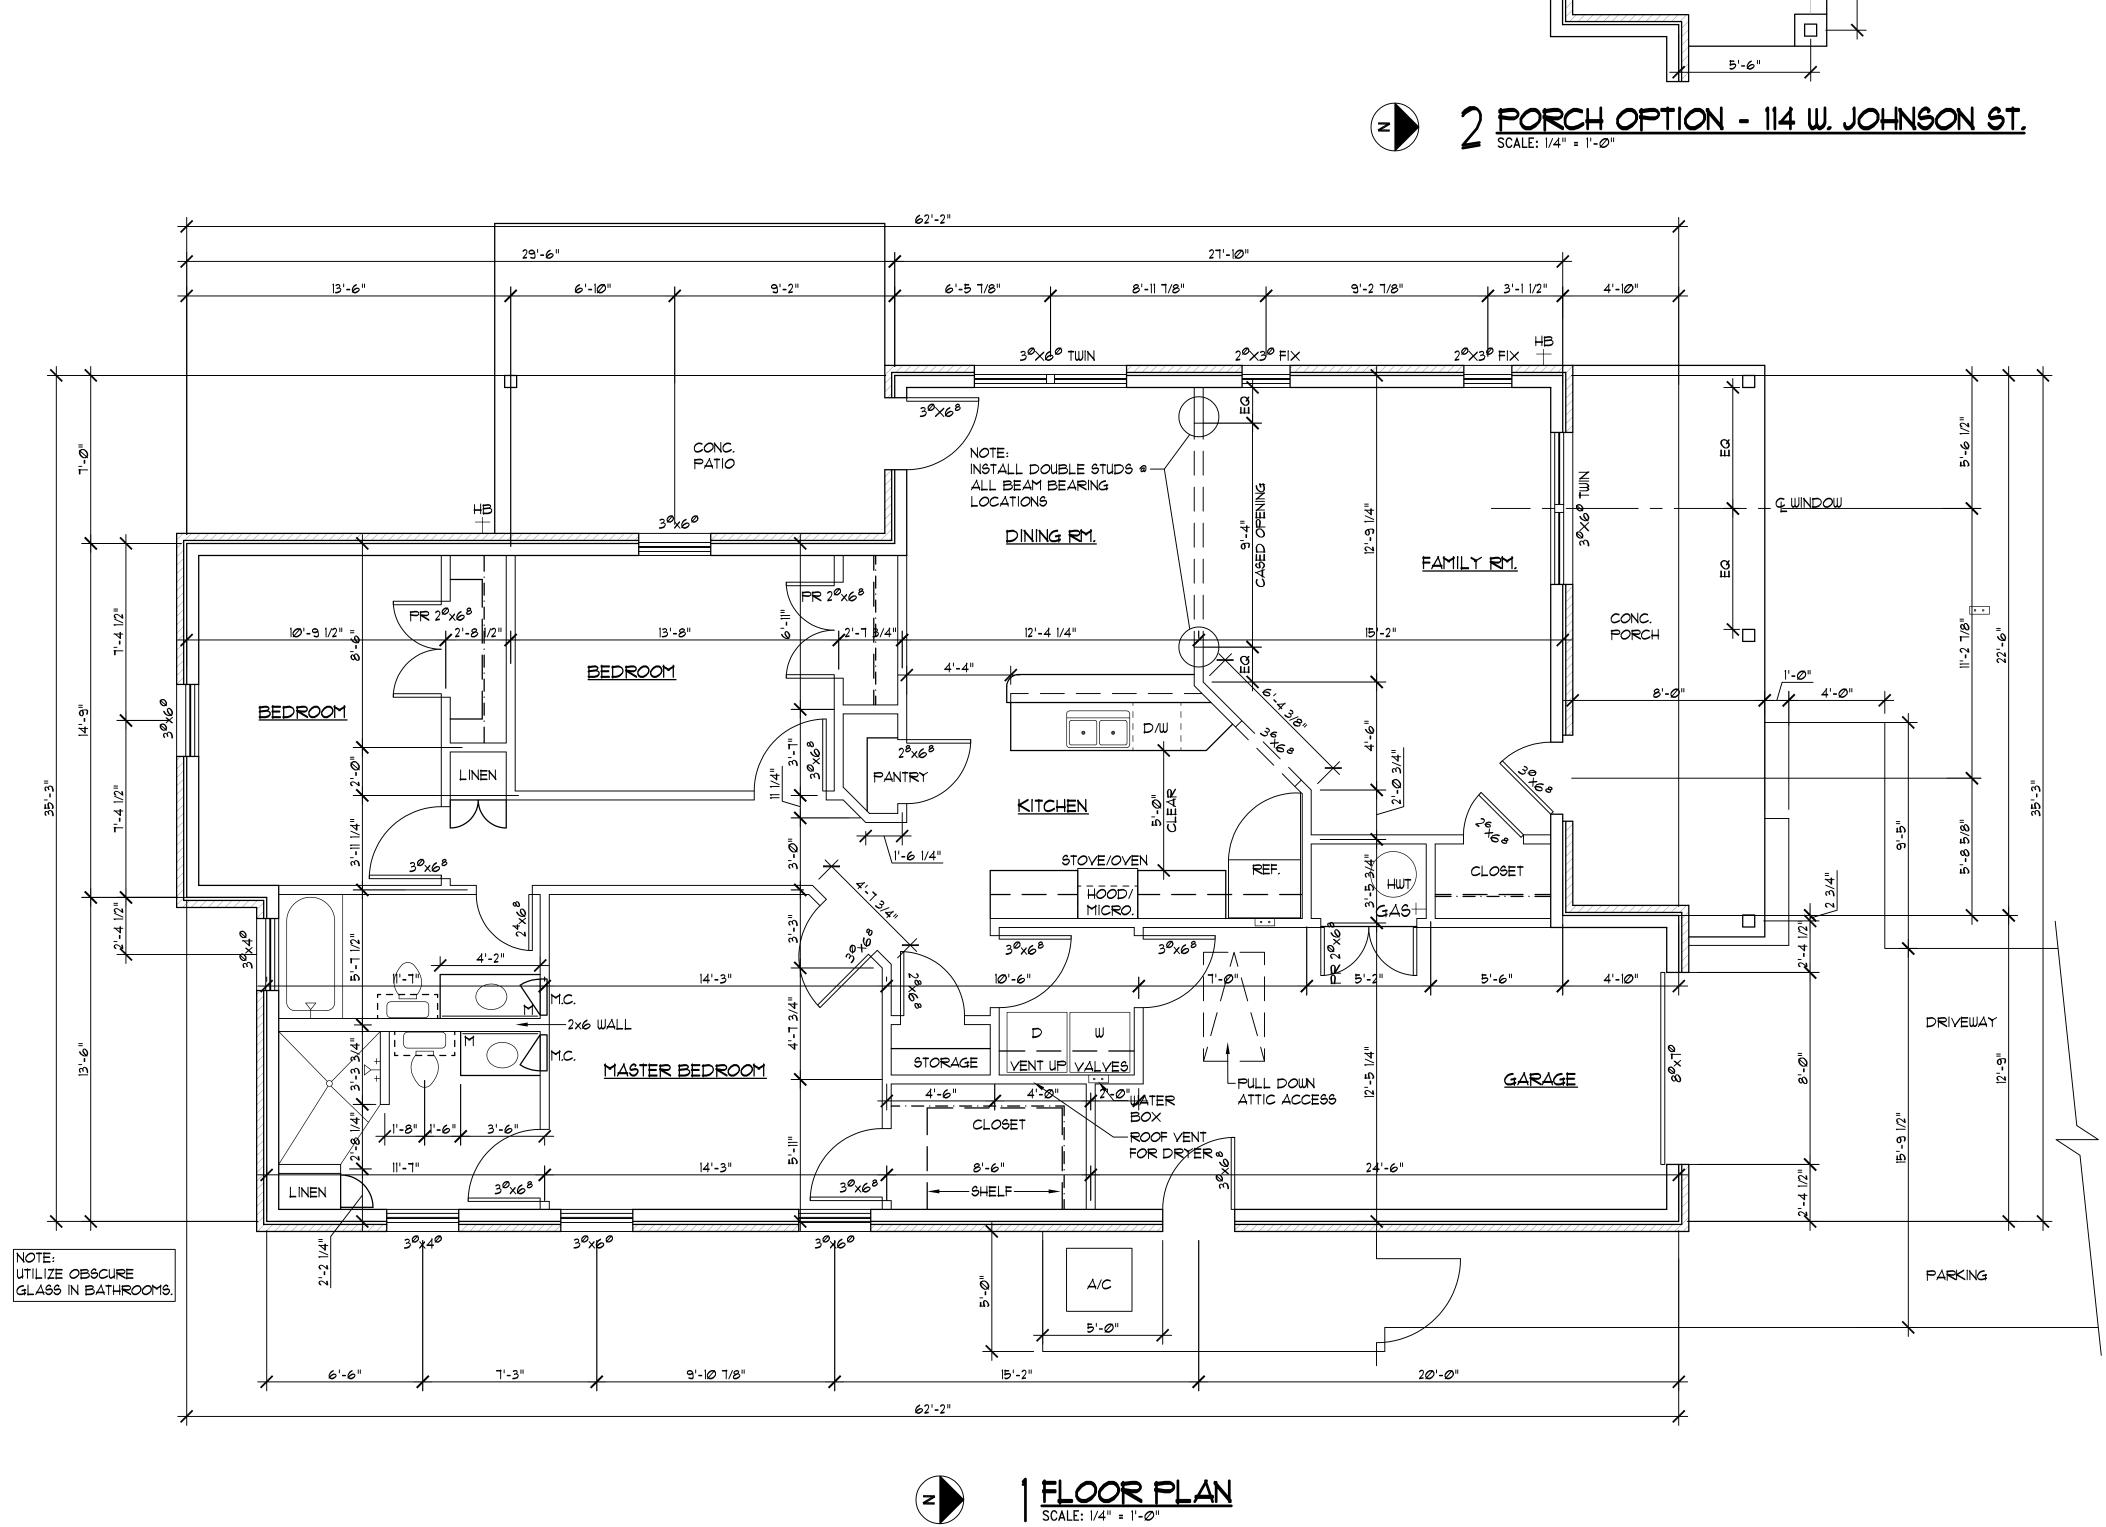
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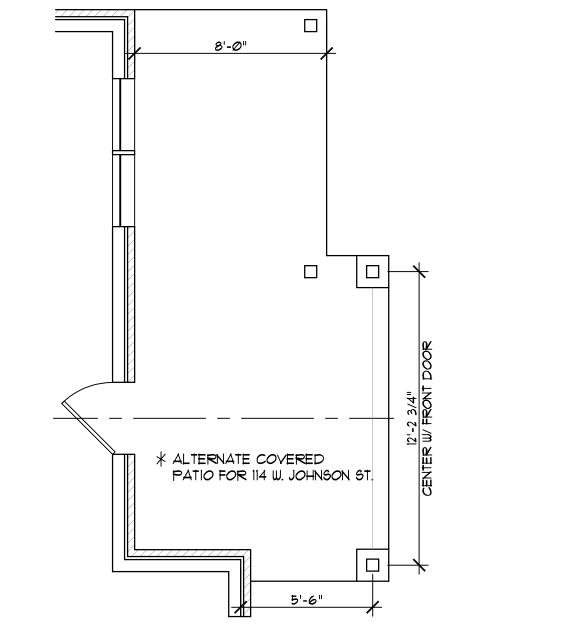
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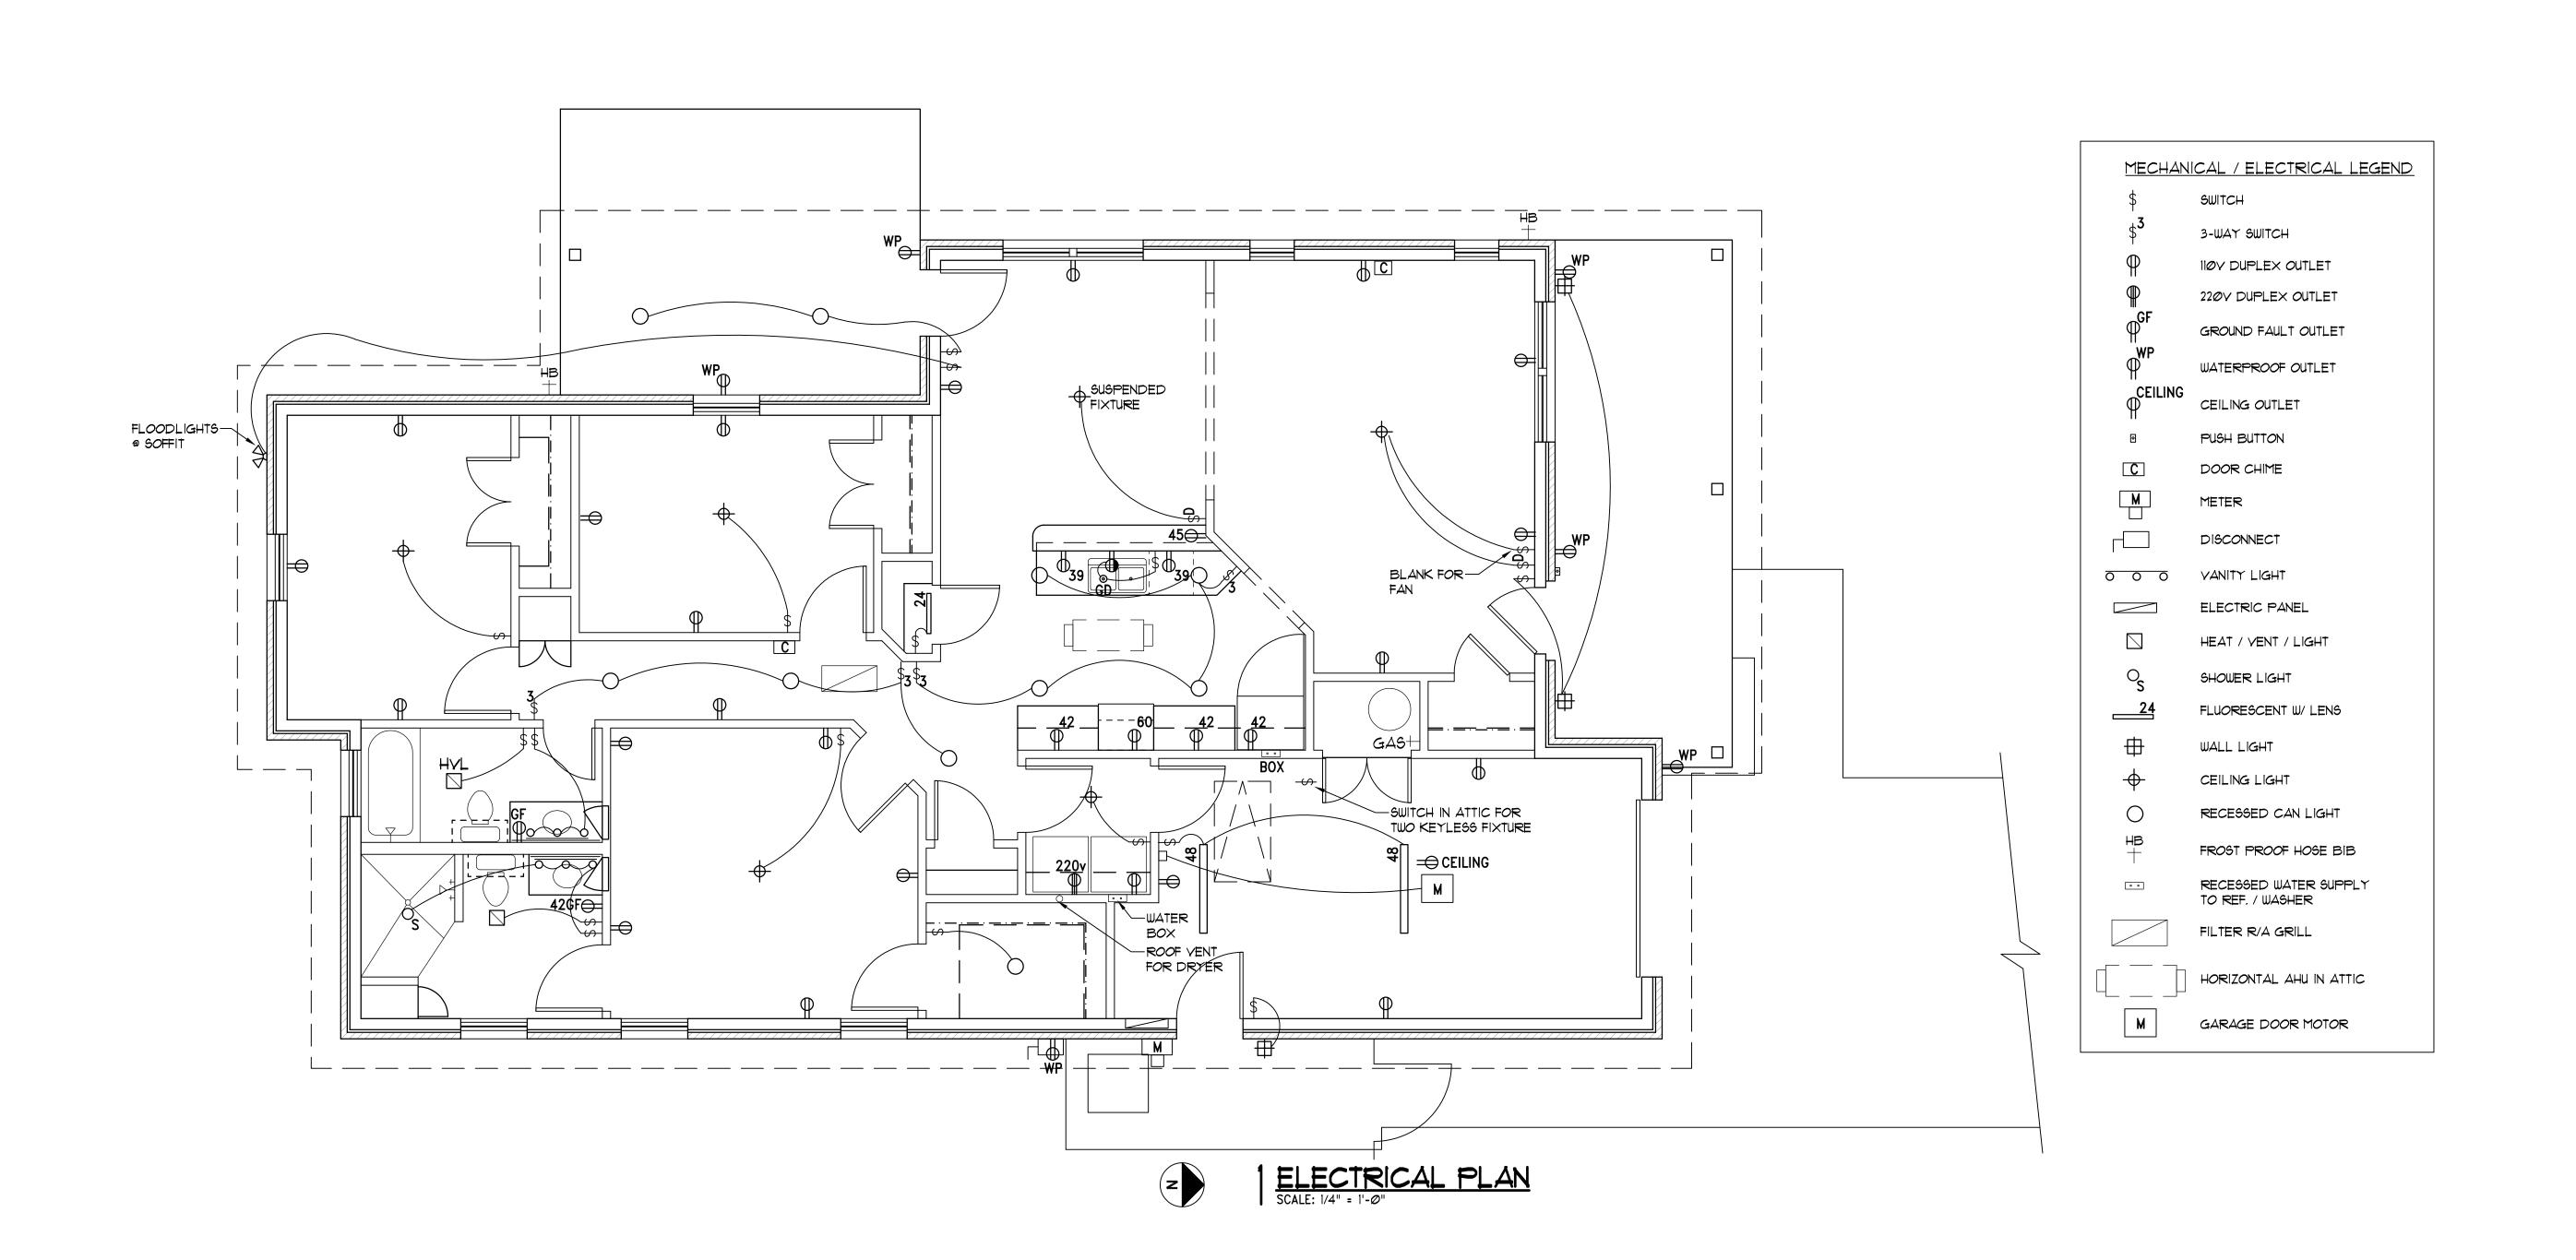
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Sheet Title: **FLOOR PLAN** 

Sheet Number:

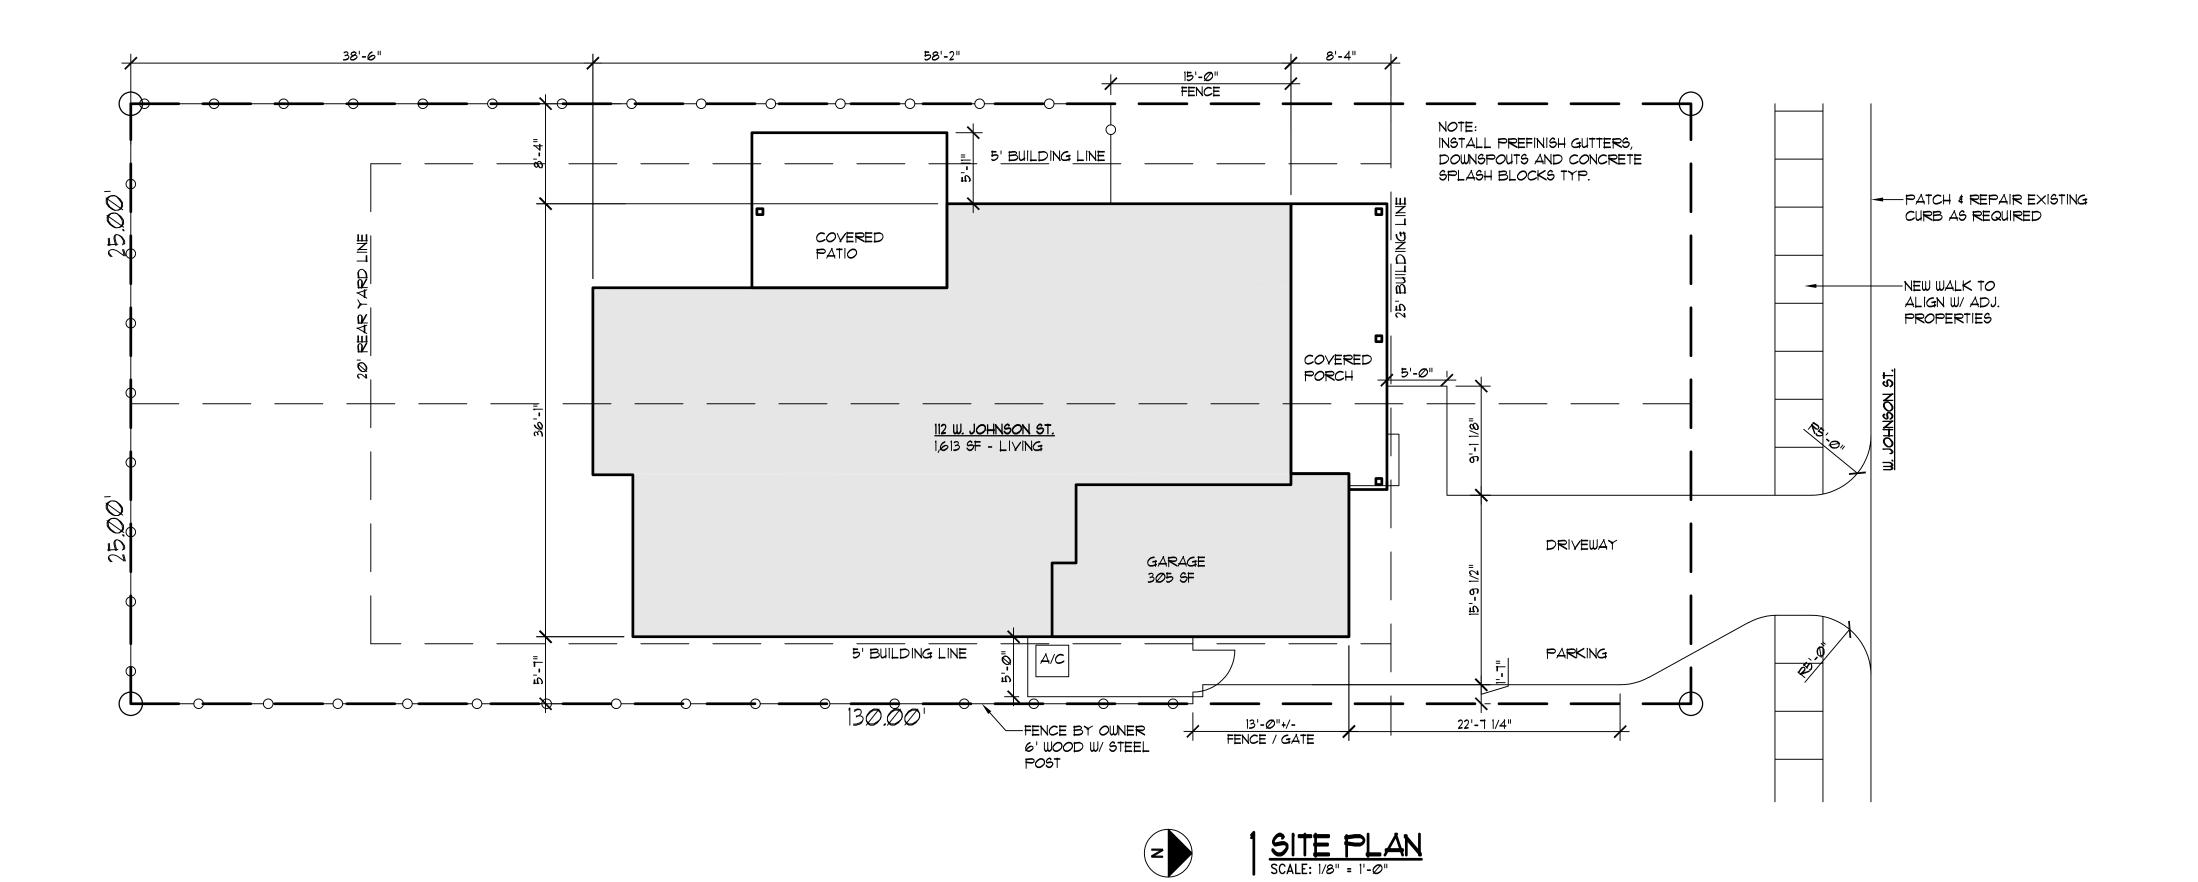


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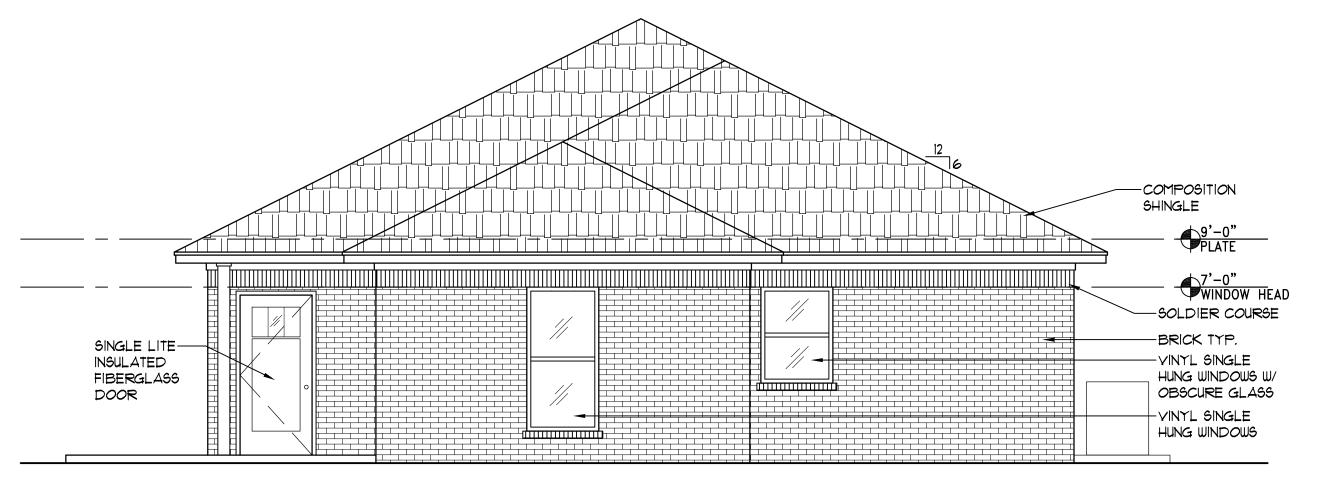
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Project Number: HS025220

Sheet Title: **ELECTRICAL PLAN** 

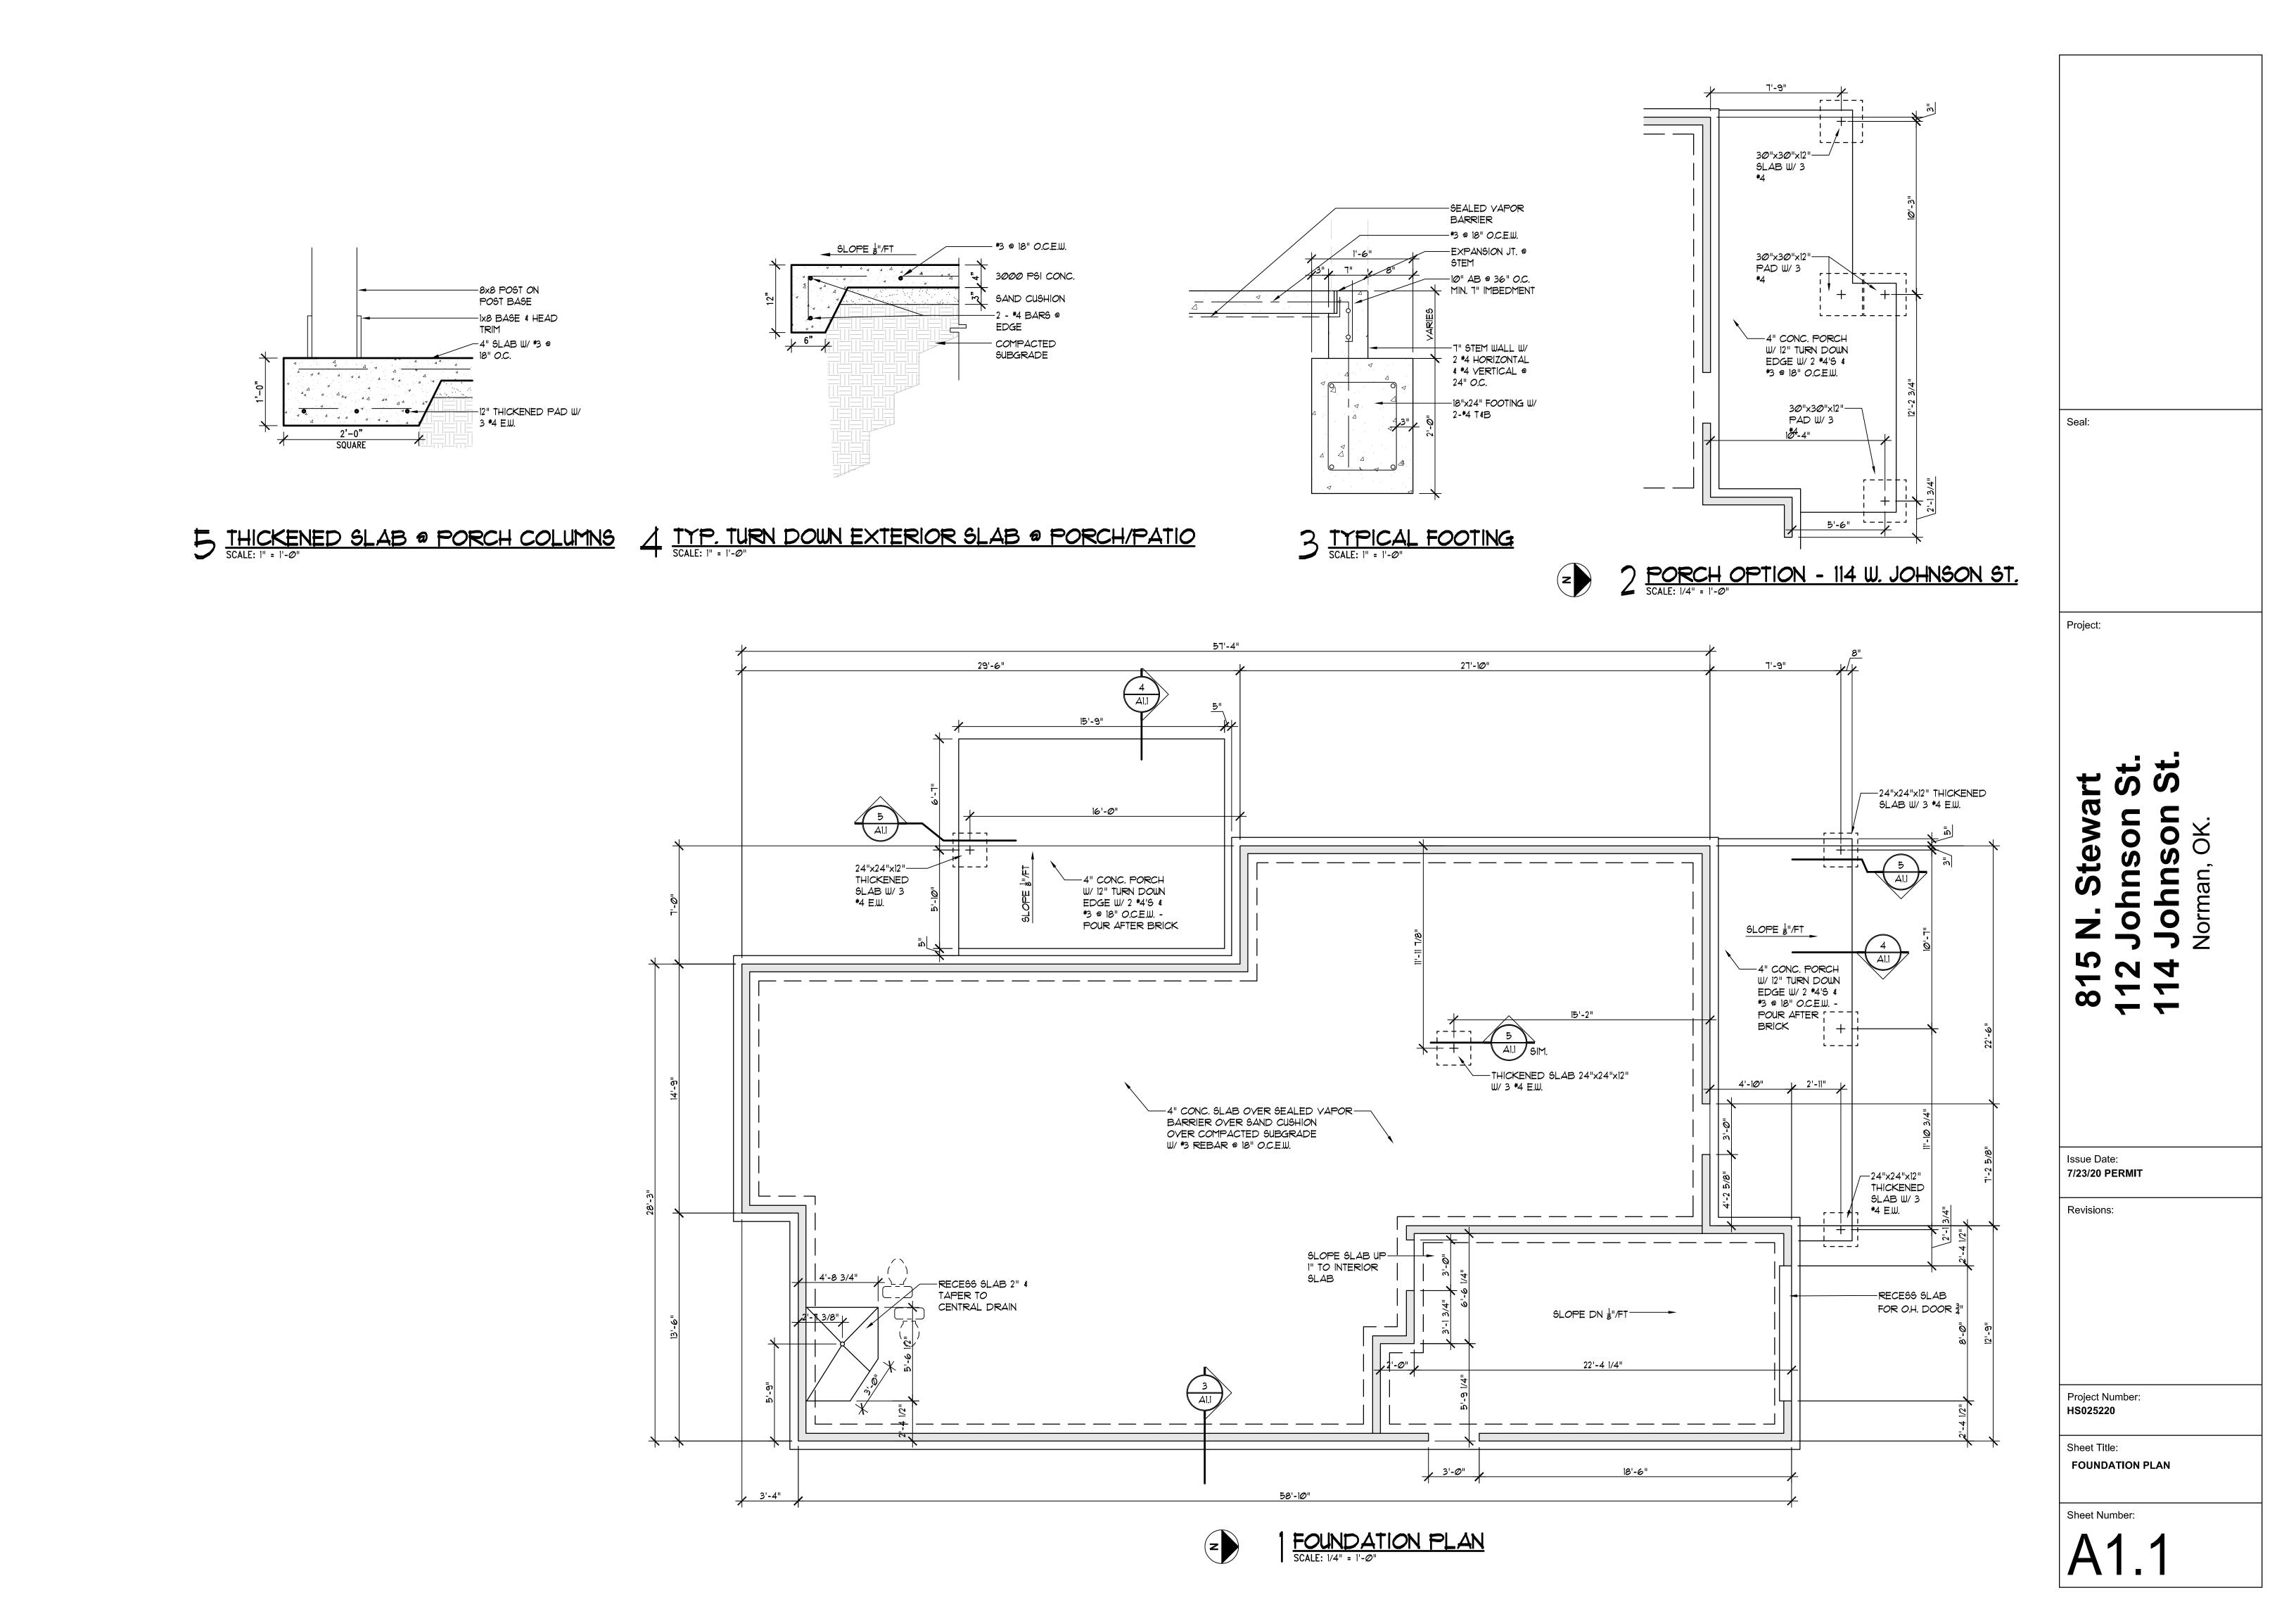Sheet Number:




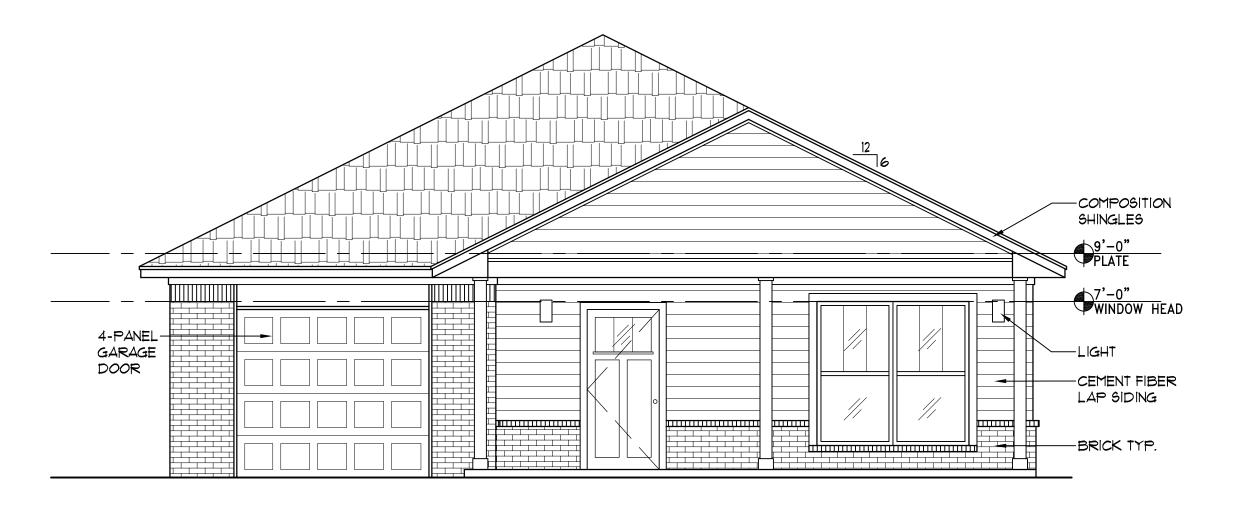

FRONT ELEVATION - 112 W. JOHNSON ST.

SCALE: 1/4" = 1'-0"

2 REAR ELEVATION
SCALE: 1/4" = 1'-0"

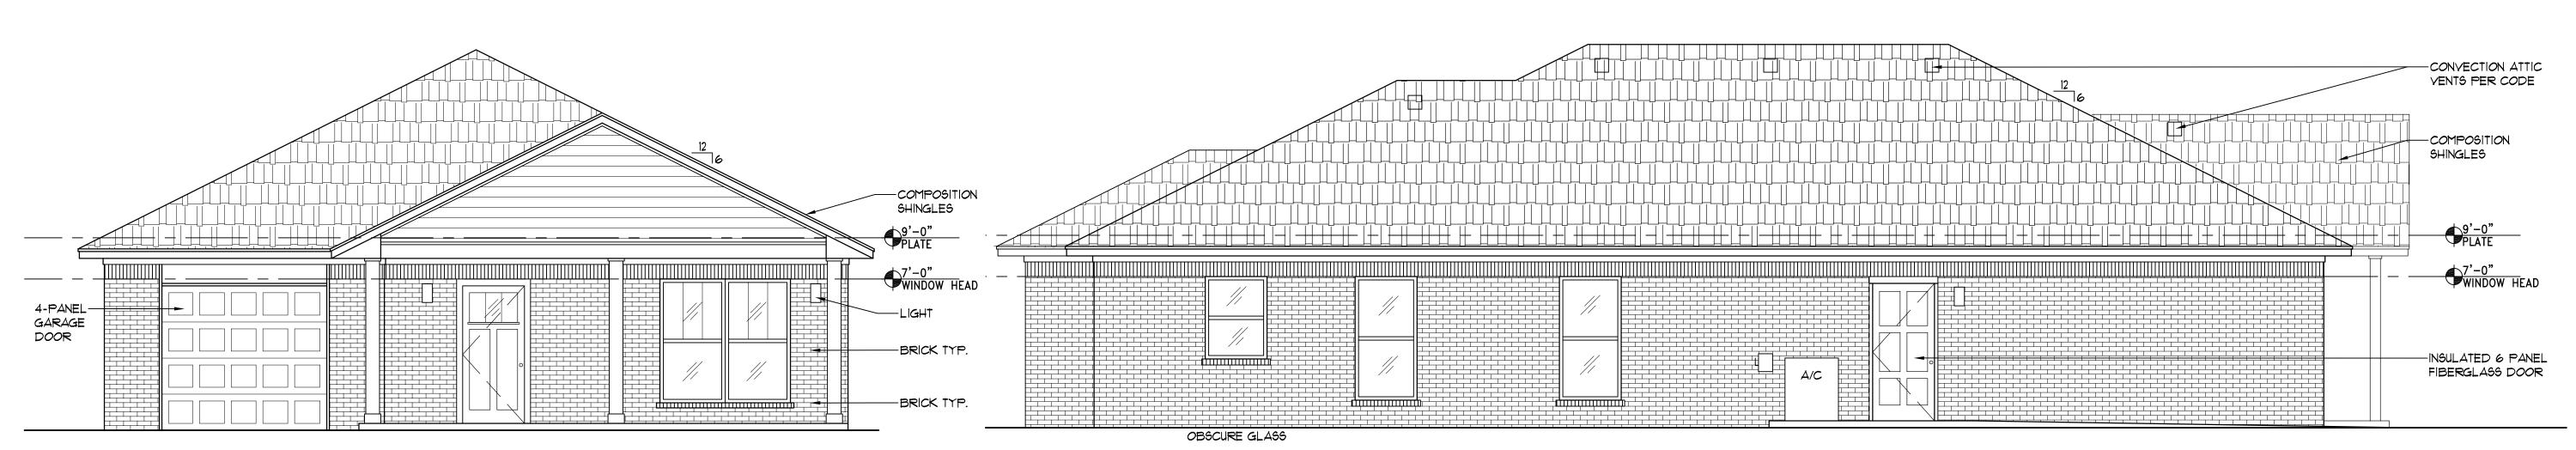

3 FRONT ELEVATION - 815 N. STEWARTT

NOTE: 815 N. STEWART TO RECEIVE 100% BRICK VENEER W/ LAP SIDING IN ENTRY GABLE LEFT ELEVATION

SCALE: 1/4" = 1'-Ø"



Seal:

Project:

112 W. Johnson St. 815 N. Stewart Norman, OK.

Issue Date: 7/23/20 PERMIT


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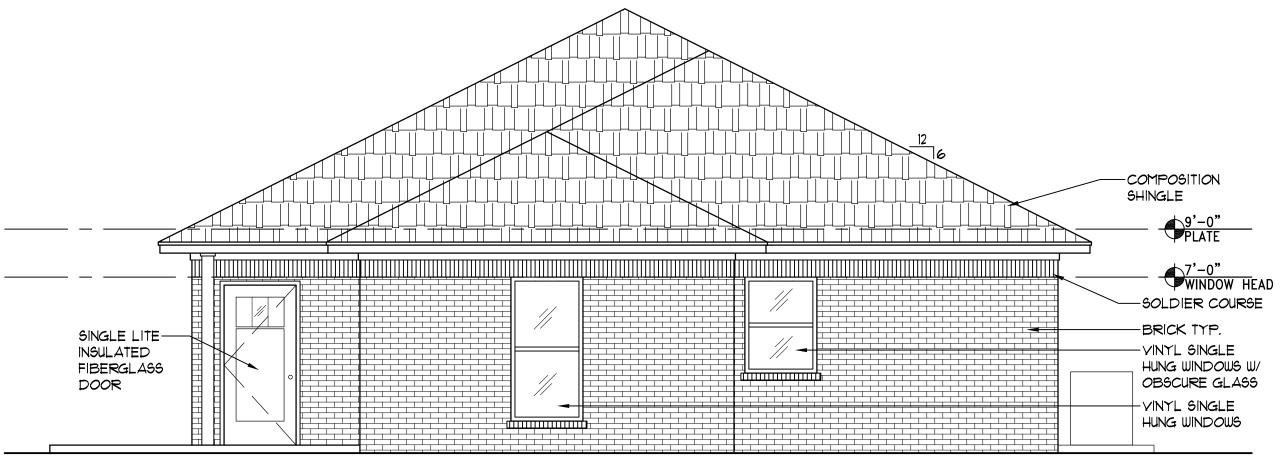
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Sheet Title:
EXTERIOR ELEVATIONS

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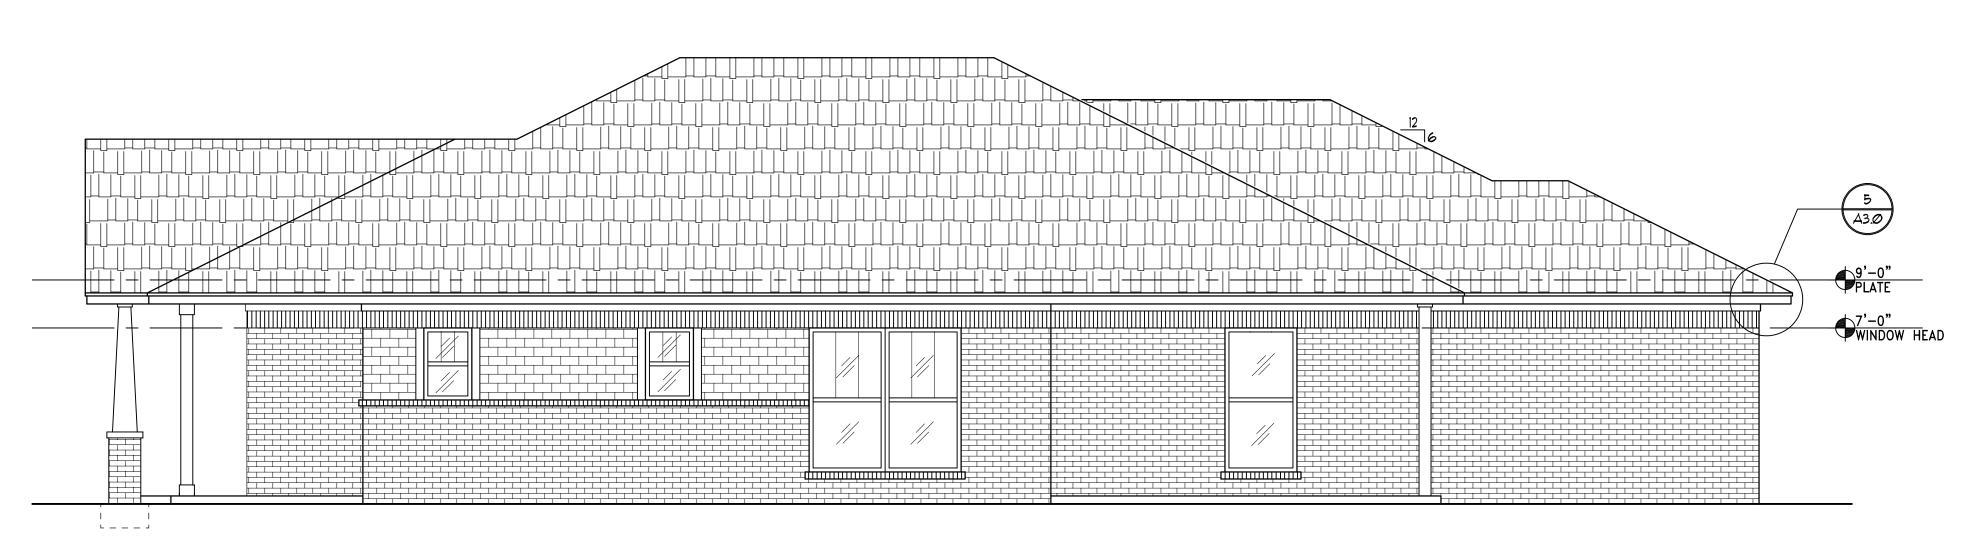





2 REAR ELEVATION
SCALE: 1/4" = 1'-0"

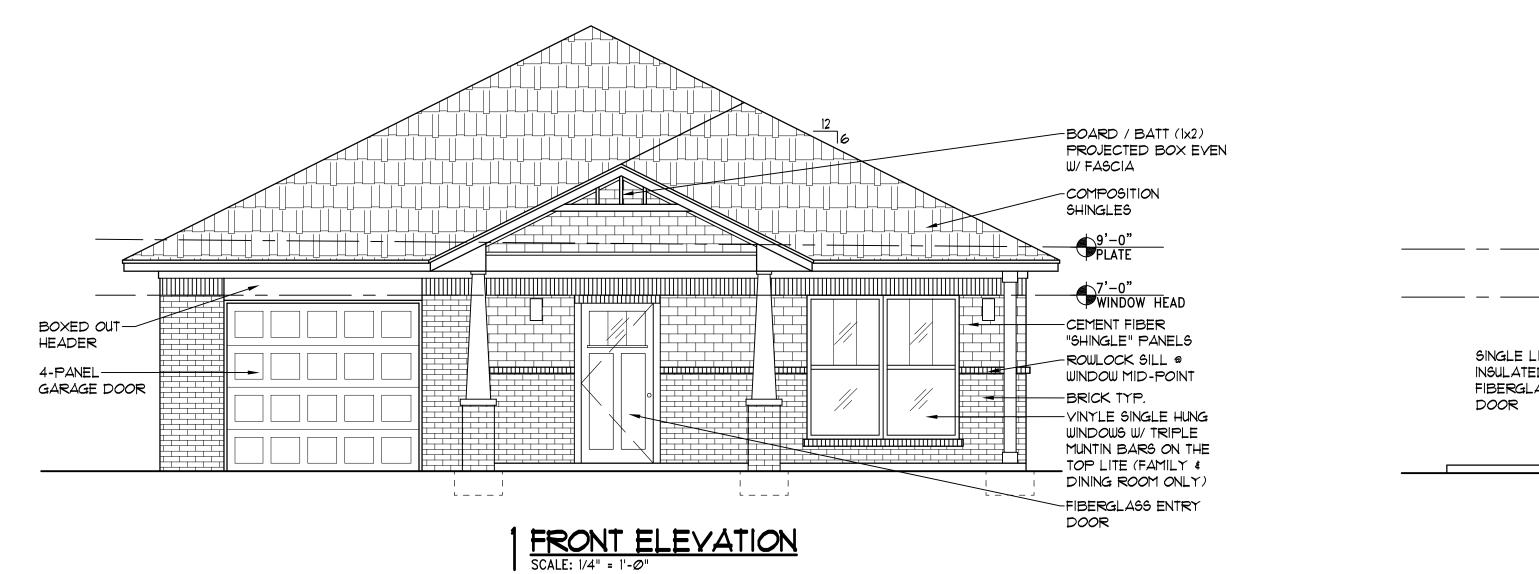

# 3 LEFT ELEVATION SCALE: 1/4" = 1'-@"



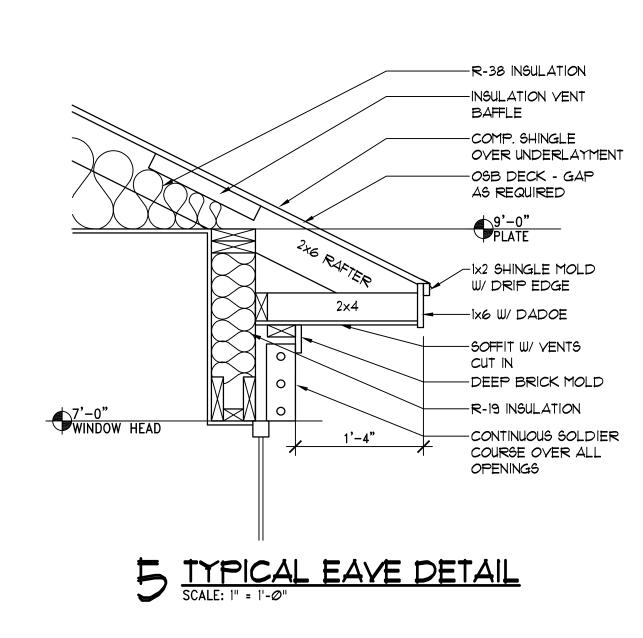

Seal:

Project:

114 Johnson St. Norman, OK.

Issue Date: 7/23/20 PERMIT

Revisions:

Project Number:

HS025220

Sheet Title:

EXTERIOR ELEVATIONS

Sheet Number:

RIGHT ELEVATION
SCALE: 1/4" = 1'-0"